### CITY OF ST. PAUL REQUIREMENTS:

INSPECTION CONTACT: The developer shall contact the Right of Way inspector Dick Rohland 651-485-1688 (one week prior to beginning work) to discuss traffic control, pedestrian safety and coordination of all work in the public right of way. Note: If a one week notice is not provided to the City, any resulting delays shall be the sole responsibility of the Contractor.

SAFE WORK SITE REQUIREMENTS: The Contractor shall provide a continuous, accessible and safe pedestrian walkway that meets ADA and MN MUTCD standards if working in a sidewalk area, and traffic control per MN MUTCD requirements for work in the public right of

utility feeds to the site. Coordinate with each utility prior to construction to determine feed points into the property. Utilities are responsible for securing excavation permits to run their service into a site, and (where required) submitting plans for review by the Public Works Utility Review Committee.

ROADWAY RESTORATION: As per the City's "Standard Specification for Street Openings" policy, restoration on roadway surfaces less than 5 years old will require full width mill and overlay or additional degradation fees. Degradation fees are determined by contacting the

NO PRIVATE FACILITIES IN THE RIGHT OF WAY: The developer is strictly prohibited from installing private electrical wiring, conduit, receptacles and/or lighting in the City's Right of Way. This includes stubbing conduit or cable into the public right of way to accommodate

Right of Way Service Desk at (651) 266-6151. Pavement restoration shall be completed by the St. Paul Public Works Street Maintenance Division. All related costs are the responsibility of the developer/contractor. Contact Street Maintenance at (651) 266-9700 for estimate of costs for pavement restoration.

SIGNAGE: Signs regulating parking and/or traffic on private property shall be installed by the property owner or contractor outside of the public right-of-way (ROW). Removal of signs within the public ROW shall be completed by the City. New signs or the reinstallation of existing signs, as approved by Public Works Traffic Engineering, regulating parking and/or traffic in the public ROW for this development shall be installed by the City at the expense of the development. Contact Mike Miller of Public Works 651-266-9778 two weeks in advance of needed sign work."

#### CITY OF ST. PAUL PERMIT REQUIREMENTS:


ORDERING OBSTRUCTION AND EXCAVATION PERMITS: Contact Public Works Right of Way Service Desk at (651) 266-6151. It is strongly recommended that contractors call for cost estimates prior to bidding to obtain accurate cost estimates.


OBSTRUCTION PERMITS: The contractor must obtain an Obstruction Permit if construction (including silt fences) will block City streets, sidewalks or alleys, or if driving over curbs.


EXCAVATION PERMITS: All digging in the public right of way requires an Excavation Permit. If the proposed building is close to the right of way, and excavating into the right of way is needed to facilitate construction, contact the utility inspector. FAILURE TO SECURE PERMITS: Failure to secure Obstruction Permits or Excavation Permits will result in a double-permit fee and other fees required under City of St. Paul Legislative Codes.

REQUIREMENTS TO WORK IN THE PUBLIC RIGHT OF WAY: All utilities and contractors working in the public right of way must be registered, insured and bonded, as recognized by the Public Works Service Desk. (651-266-6151).

WORK IN THE RIGHT OF WAY All work on curbs, driveways, and sidewalks within the public right of way must be done to City Standards and Specifications by a licensed and bonded contractor under a permit from Public Works Sidewalk Section (651-266-6120). Sidewalk grades must be carried across driveways. Restoration of asphalt and concrete pavements are performed by the Public Works Street Maintenance Division. The contractor is responsible for payment to the City for the cost of these restorations. The contractor shall contact Public Works Street Maintenance to set up a work order prior to beginning any removals in the street at 651-266-9700. Procedures and unit costs are found in Street Maintenance's "General Requirements - All Restorations" and are available at the permit

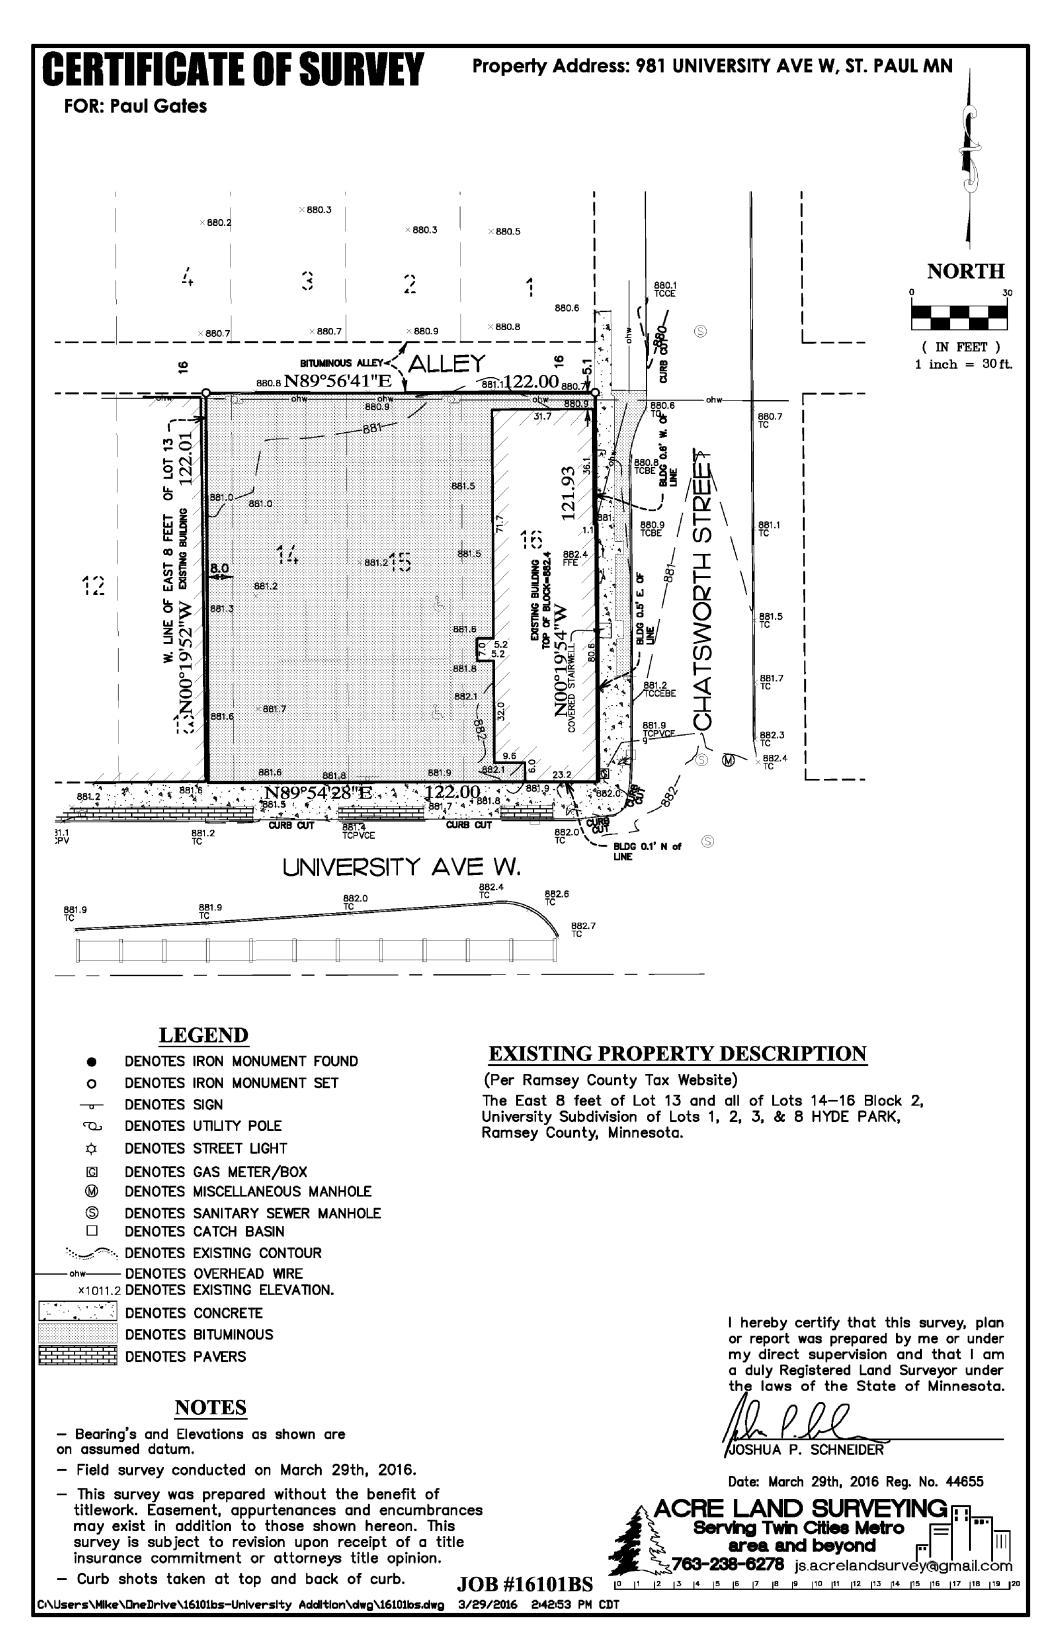

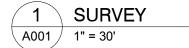

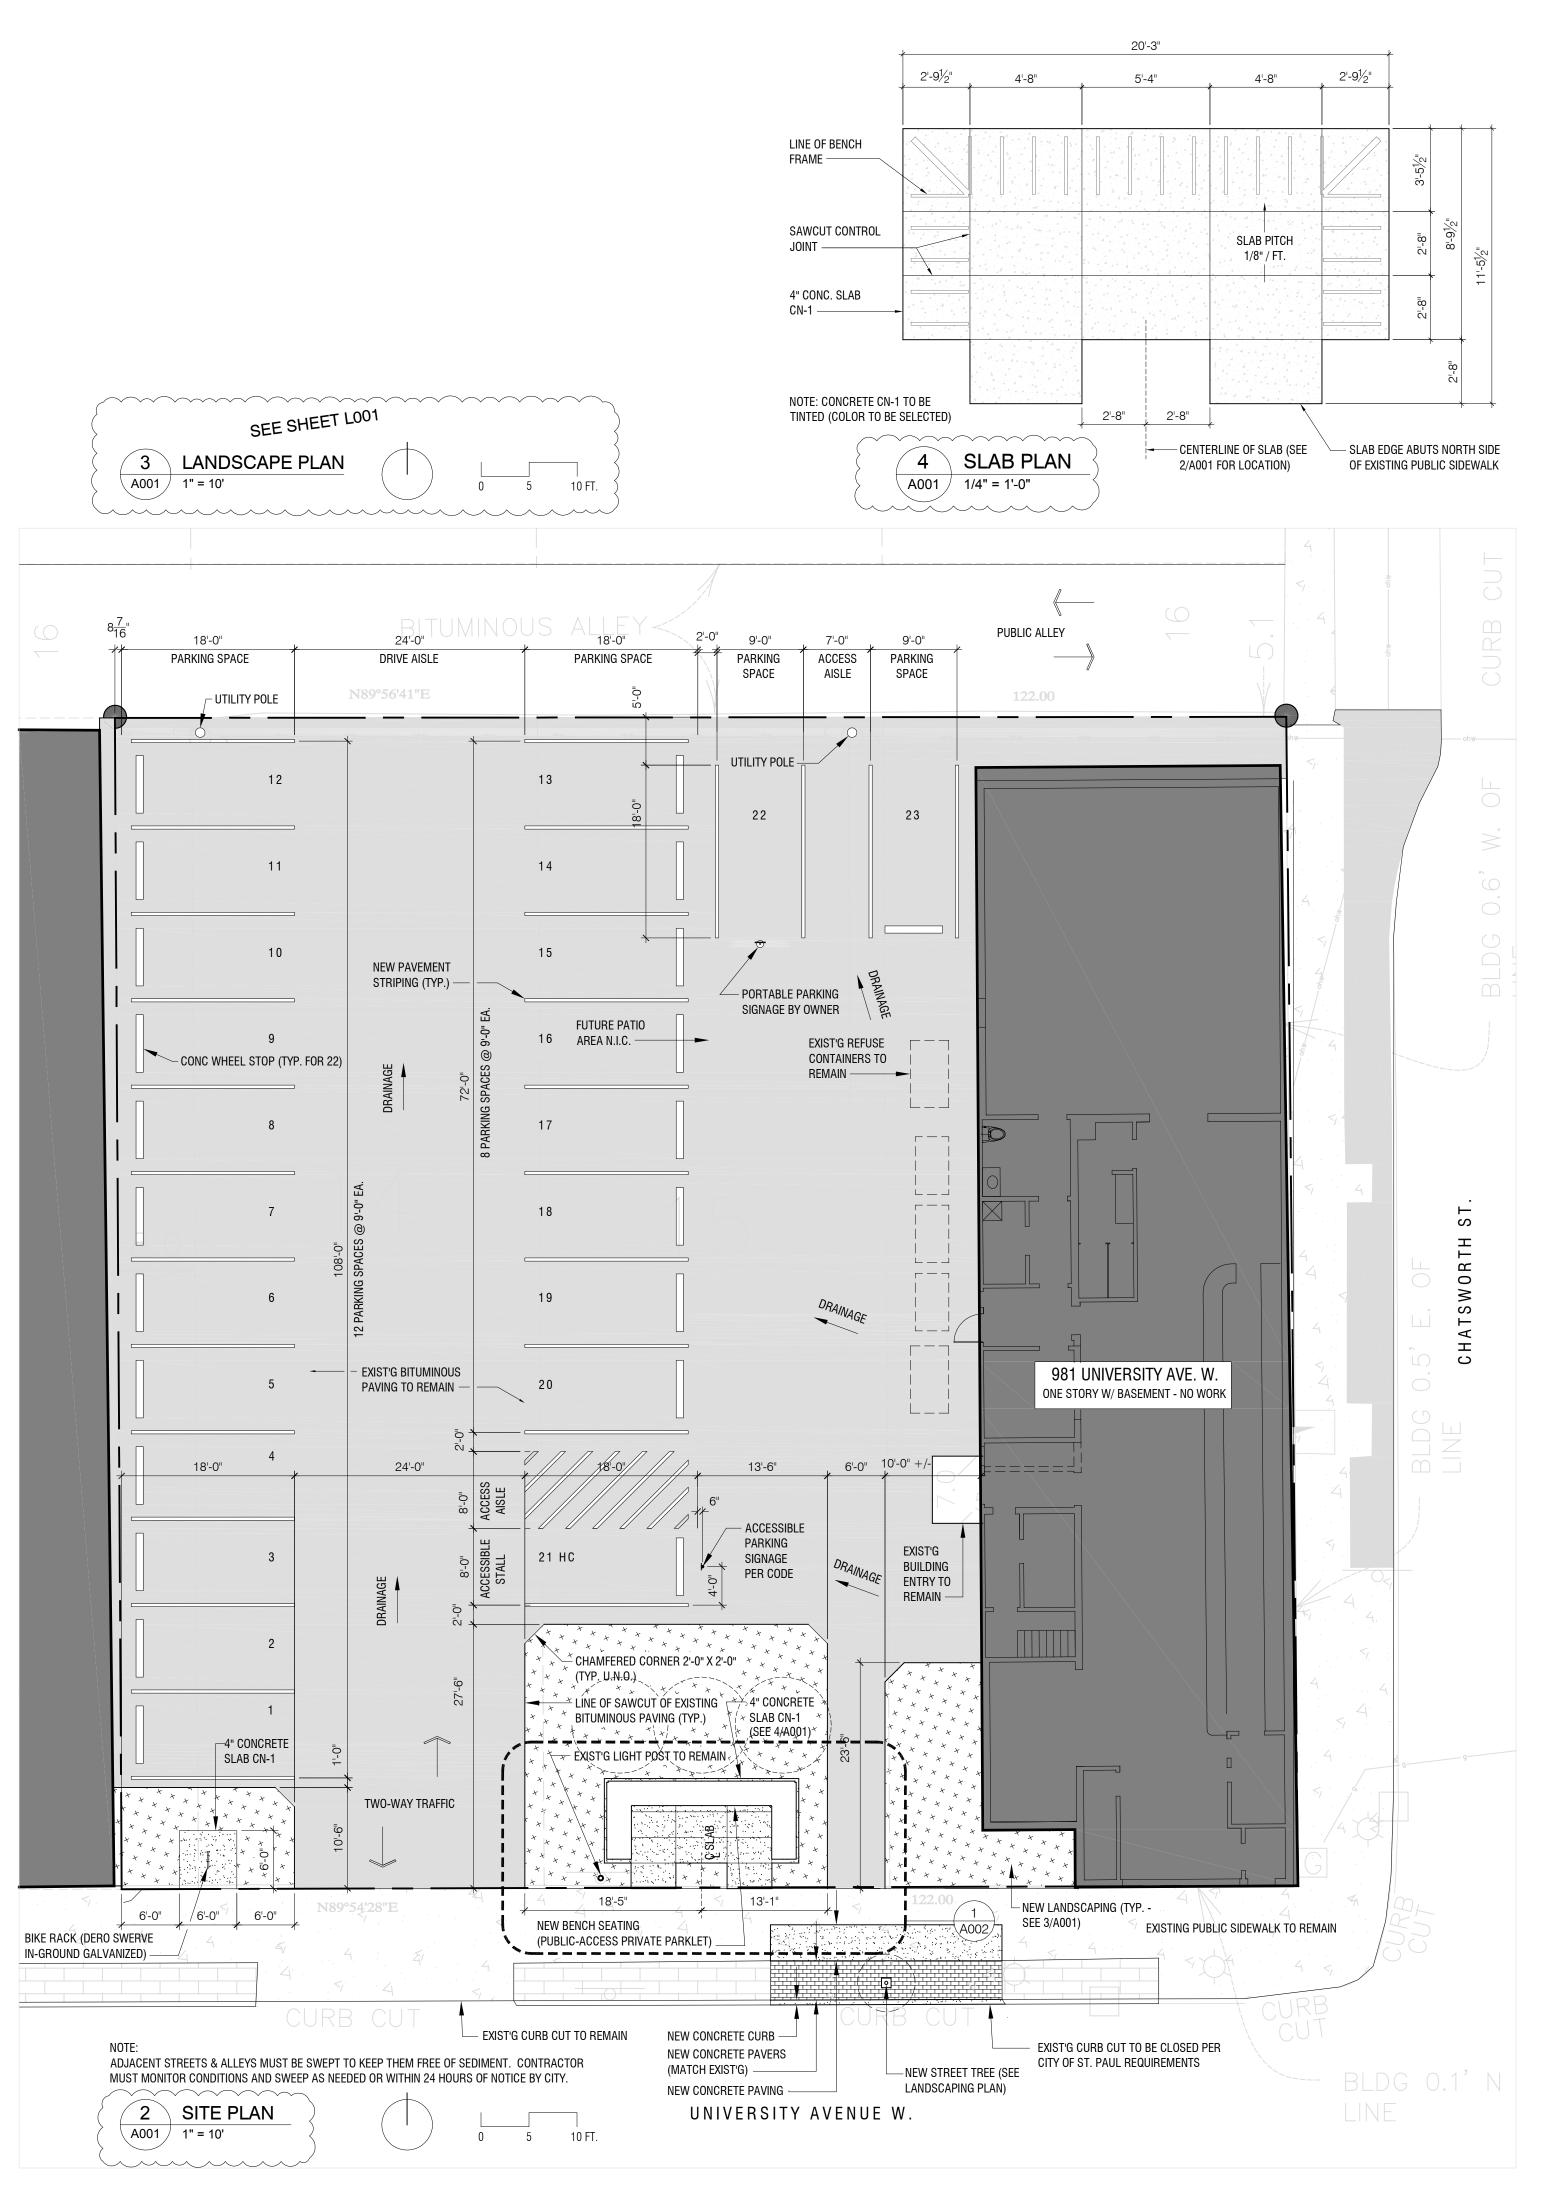

### aul Gates Tenitect

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2 East Franklin Avenue, Suite 2
Minneapolis, MN 55404
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fax 612.822.8882
Contact: Paul Gates, AIA

mobile: 612.227.3254

Project

## 981 University Ave. Parklet & Parking Improvements

981 University Avenue W. St. Paul, MN 55104

Owner

Johnny Baby's
981 Univeristy Avenue W.
St. Paul, MN 55104
contact: Jonathan Price
651.983.1151

# Development Assistance Neighborhood Development Center

663 Univeristy Avenue W. St. Paul, MN 55104 contact: Sarah Emmel 651.291.2480

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Certification

I hereby certify that this plan, specification or report was prepared by me or under my direct supervision and that I am a duly registered architect or engineer under the laws of the State of Minnesota.

08.22.16



Registration Number **40330** 

Date of Issue

June 23, 2016

Issued For

Site Plan Review

Revisions


No. Date Issue
1 08.22.16 Revision


Project Number **1412** 

Sheet Name
General Information
Site Plan
Property Survey


Sheet Number

A001

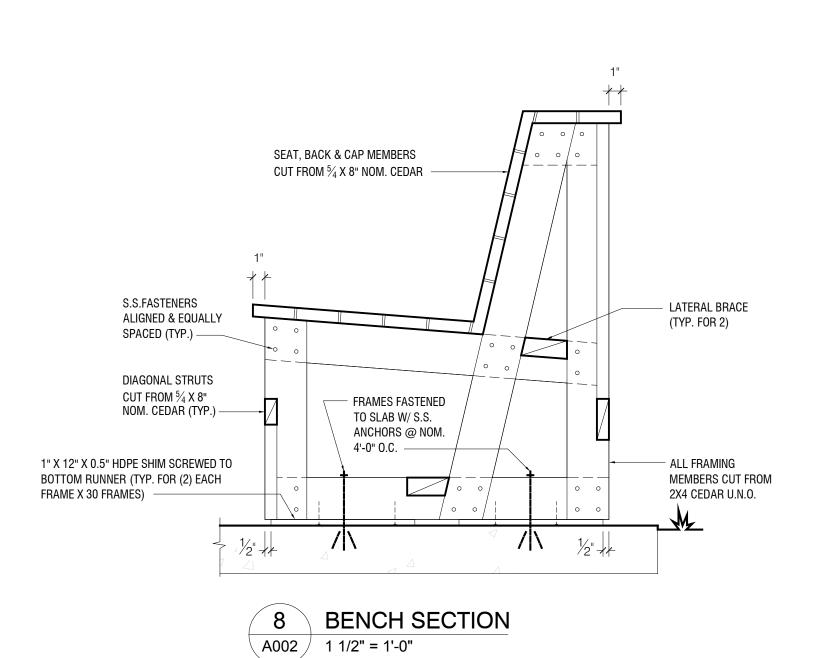

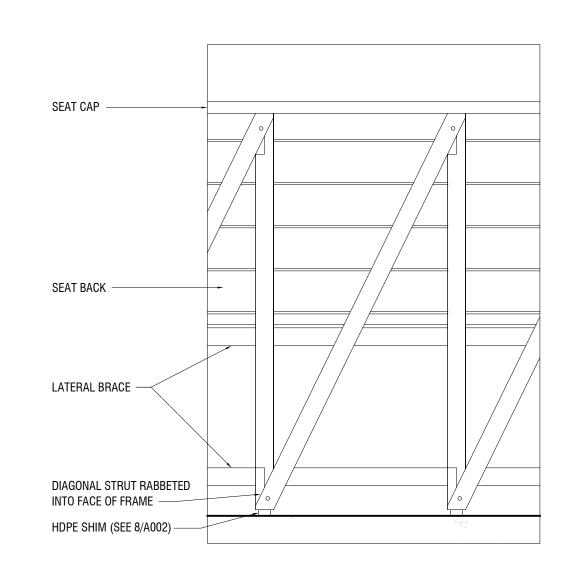

A002 1 1/2" = 1'-0"

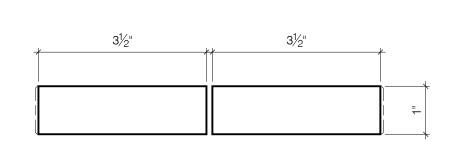



**ELEVATION DETAIL** 


TYP SEAT, BACK & CAP MEMBERS CUT FROM  $\frac{5}{4}$  X 8" NOM. CEDAR

A002 1/2" = 1'-0"

SEAT MILLING DIAGRAM A002 6" = 1'-0"

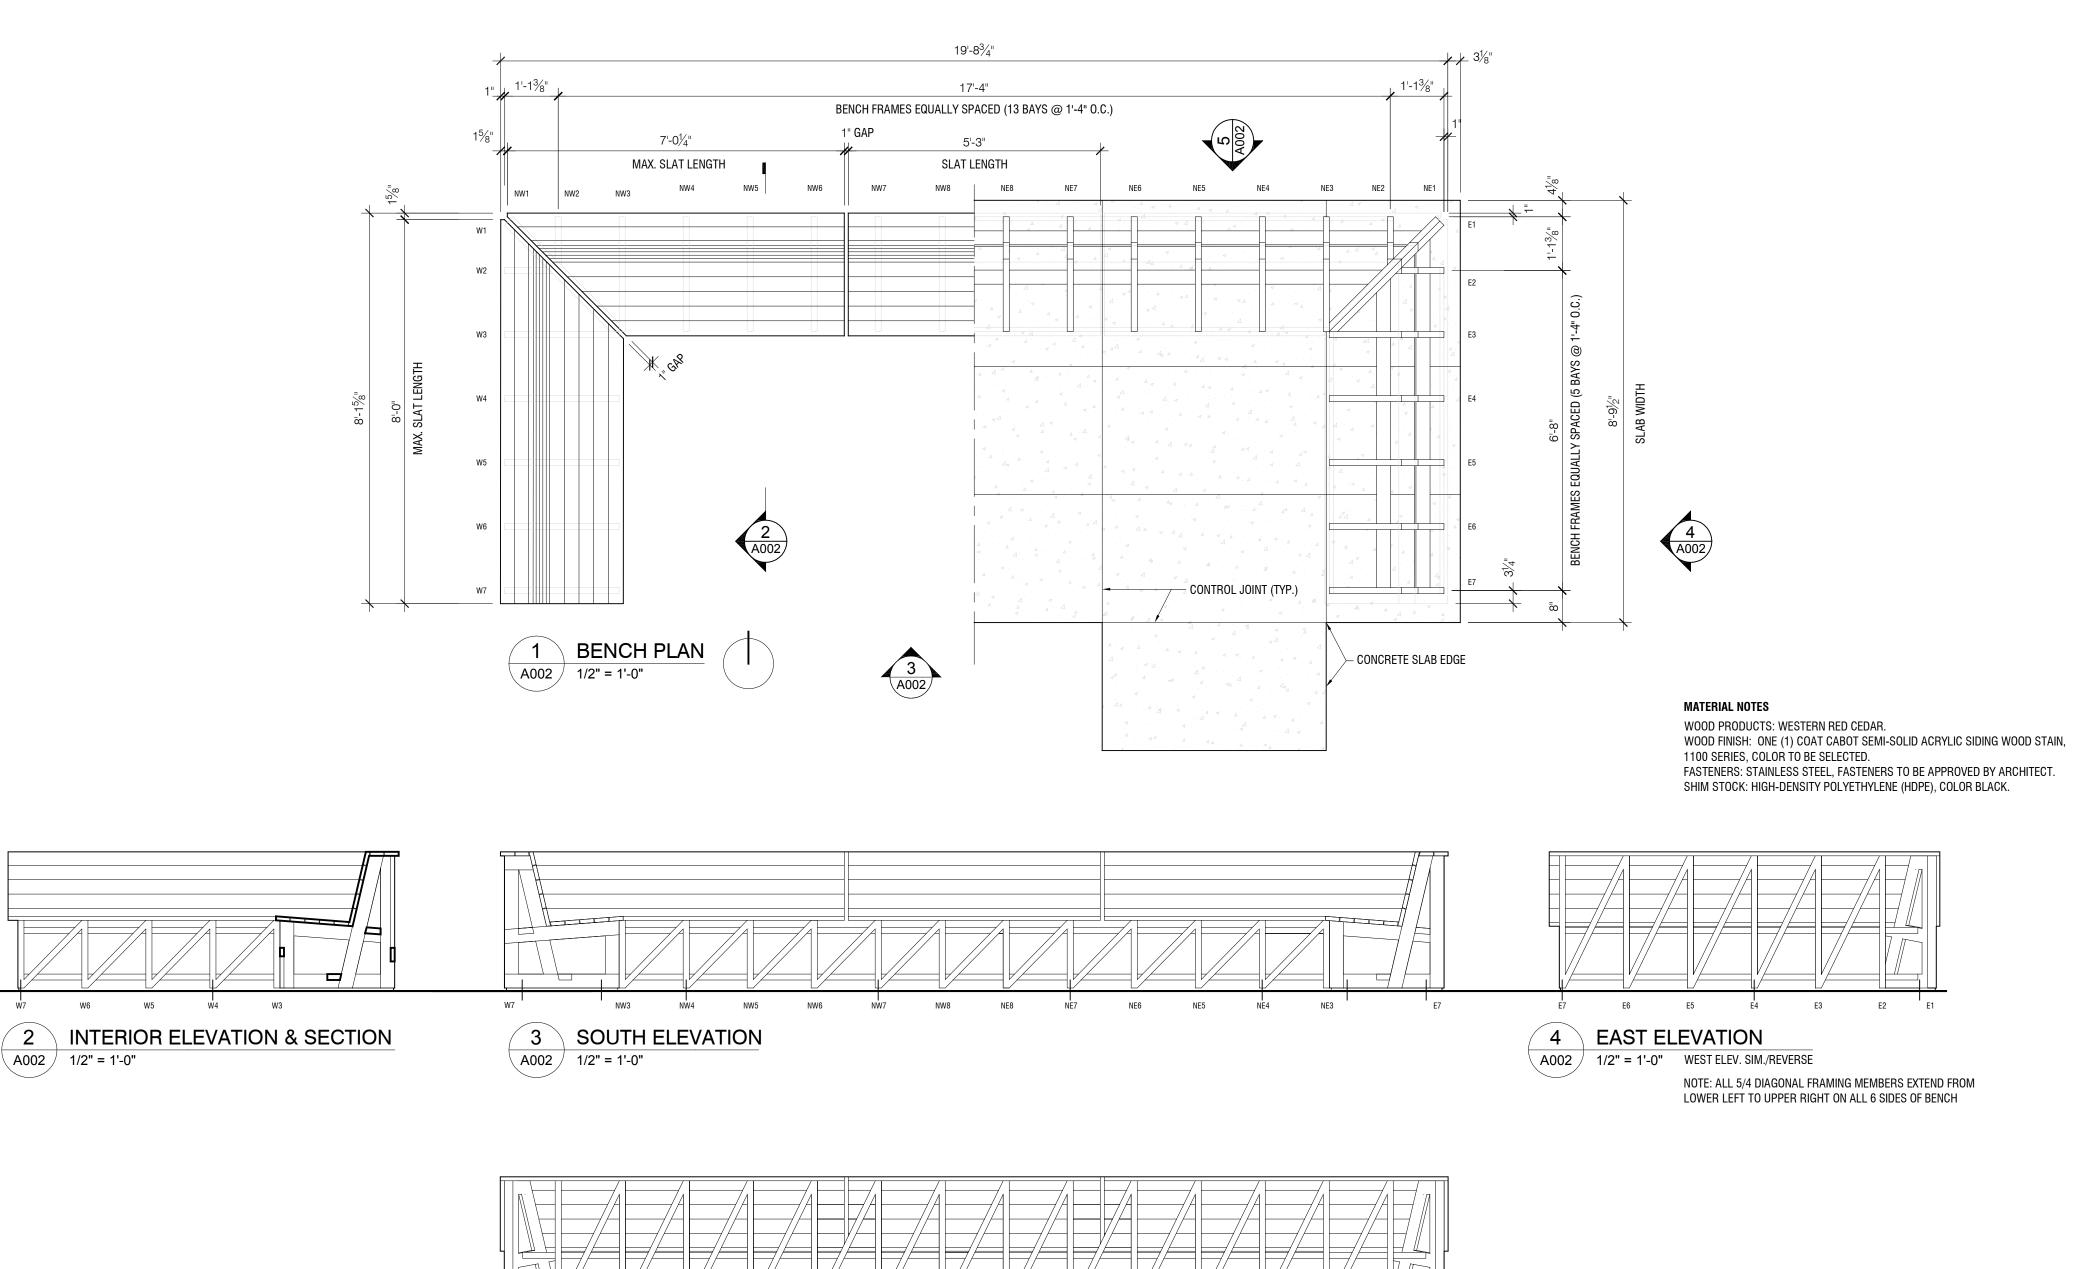

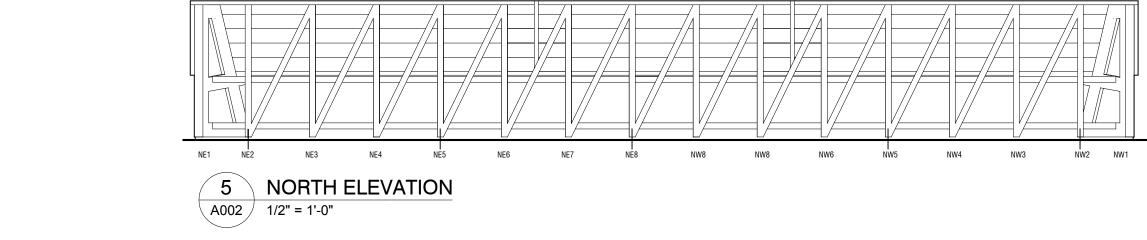

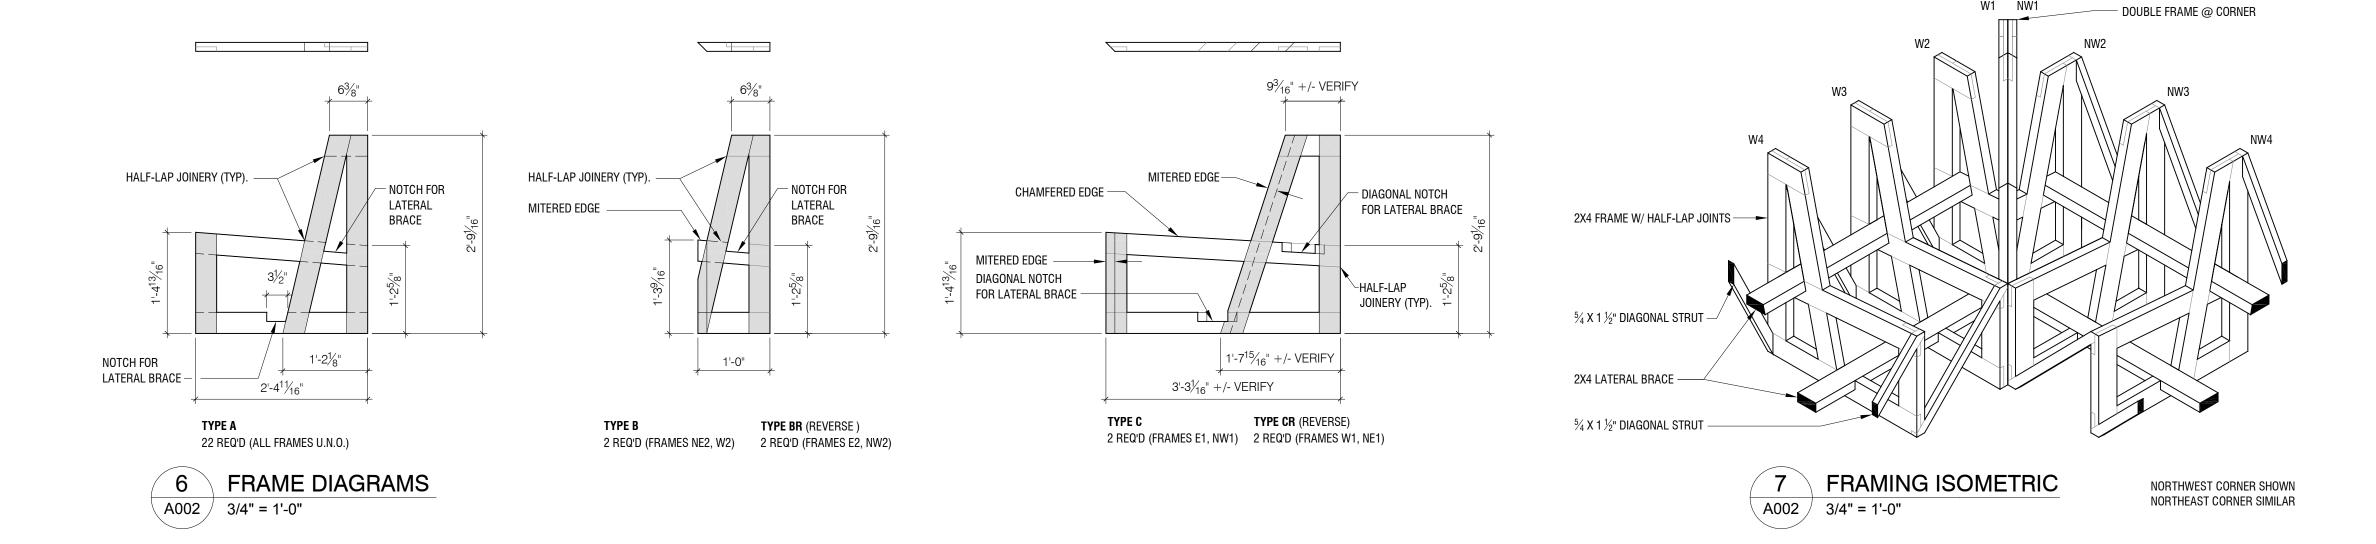

Paul Gates Architect 2 East Franklin Avenue, Suite 2 Minneapolis, MN 55404 voice 612.822.8878 fax 612.822.8882 Contact: Paul Gates, AIA mobile: 612.227.3254

Project

981 University Ave.
Parklet & Parking Improvements 981 University Avenue W.

Owner

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St. Paul, MN 55104

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Certification

I hereby certify that this plan, specification or report was prepared by me or under my direct supervision and that I am a duly registered architect or engineer under the laws of the State of Minnesota.



Registration Number 40330

08.22.16

Date of Issue August 22, 2016

Issued For

Site Plan Review & Permit


Revisions No. Date


Project Number 1412

Sheet Name

**Bench Drawings** 

Sheet Number

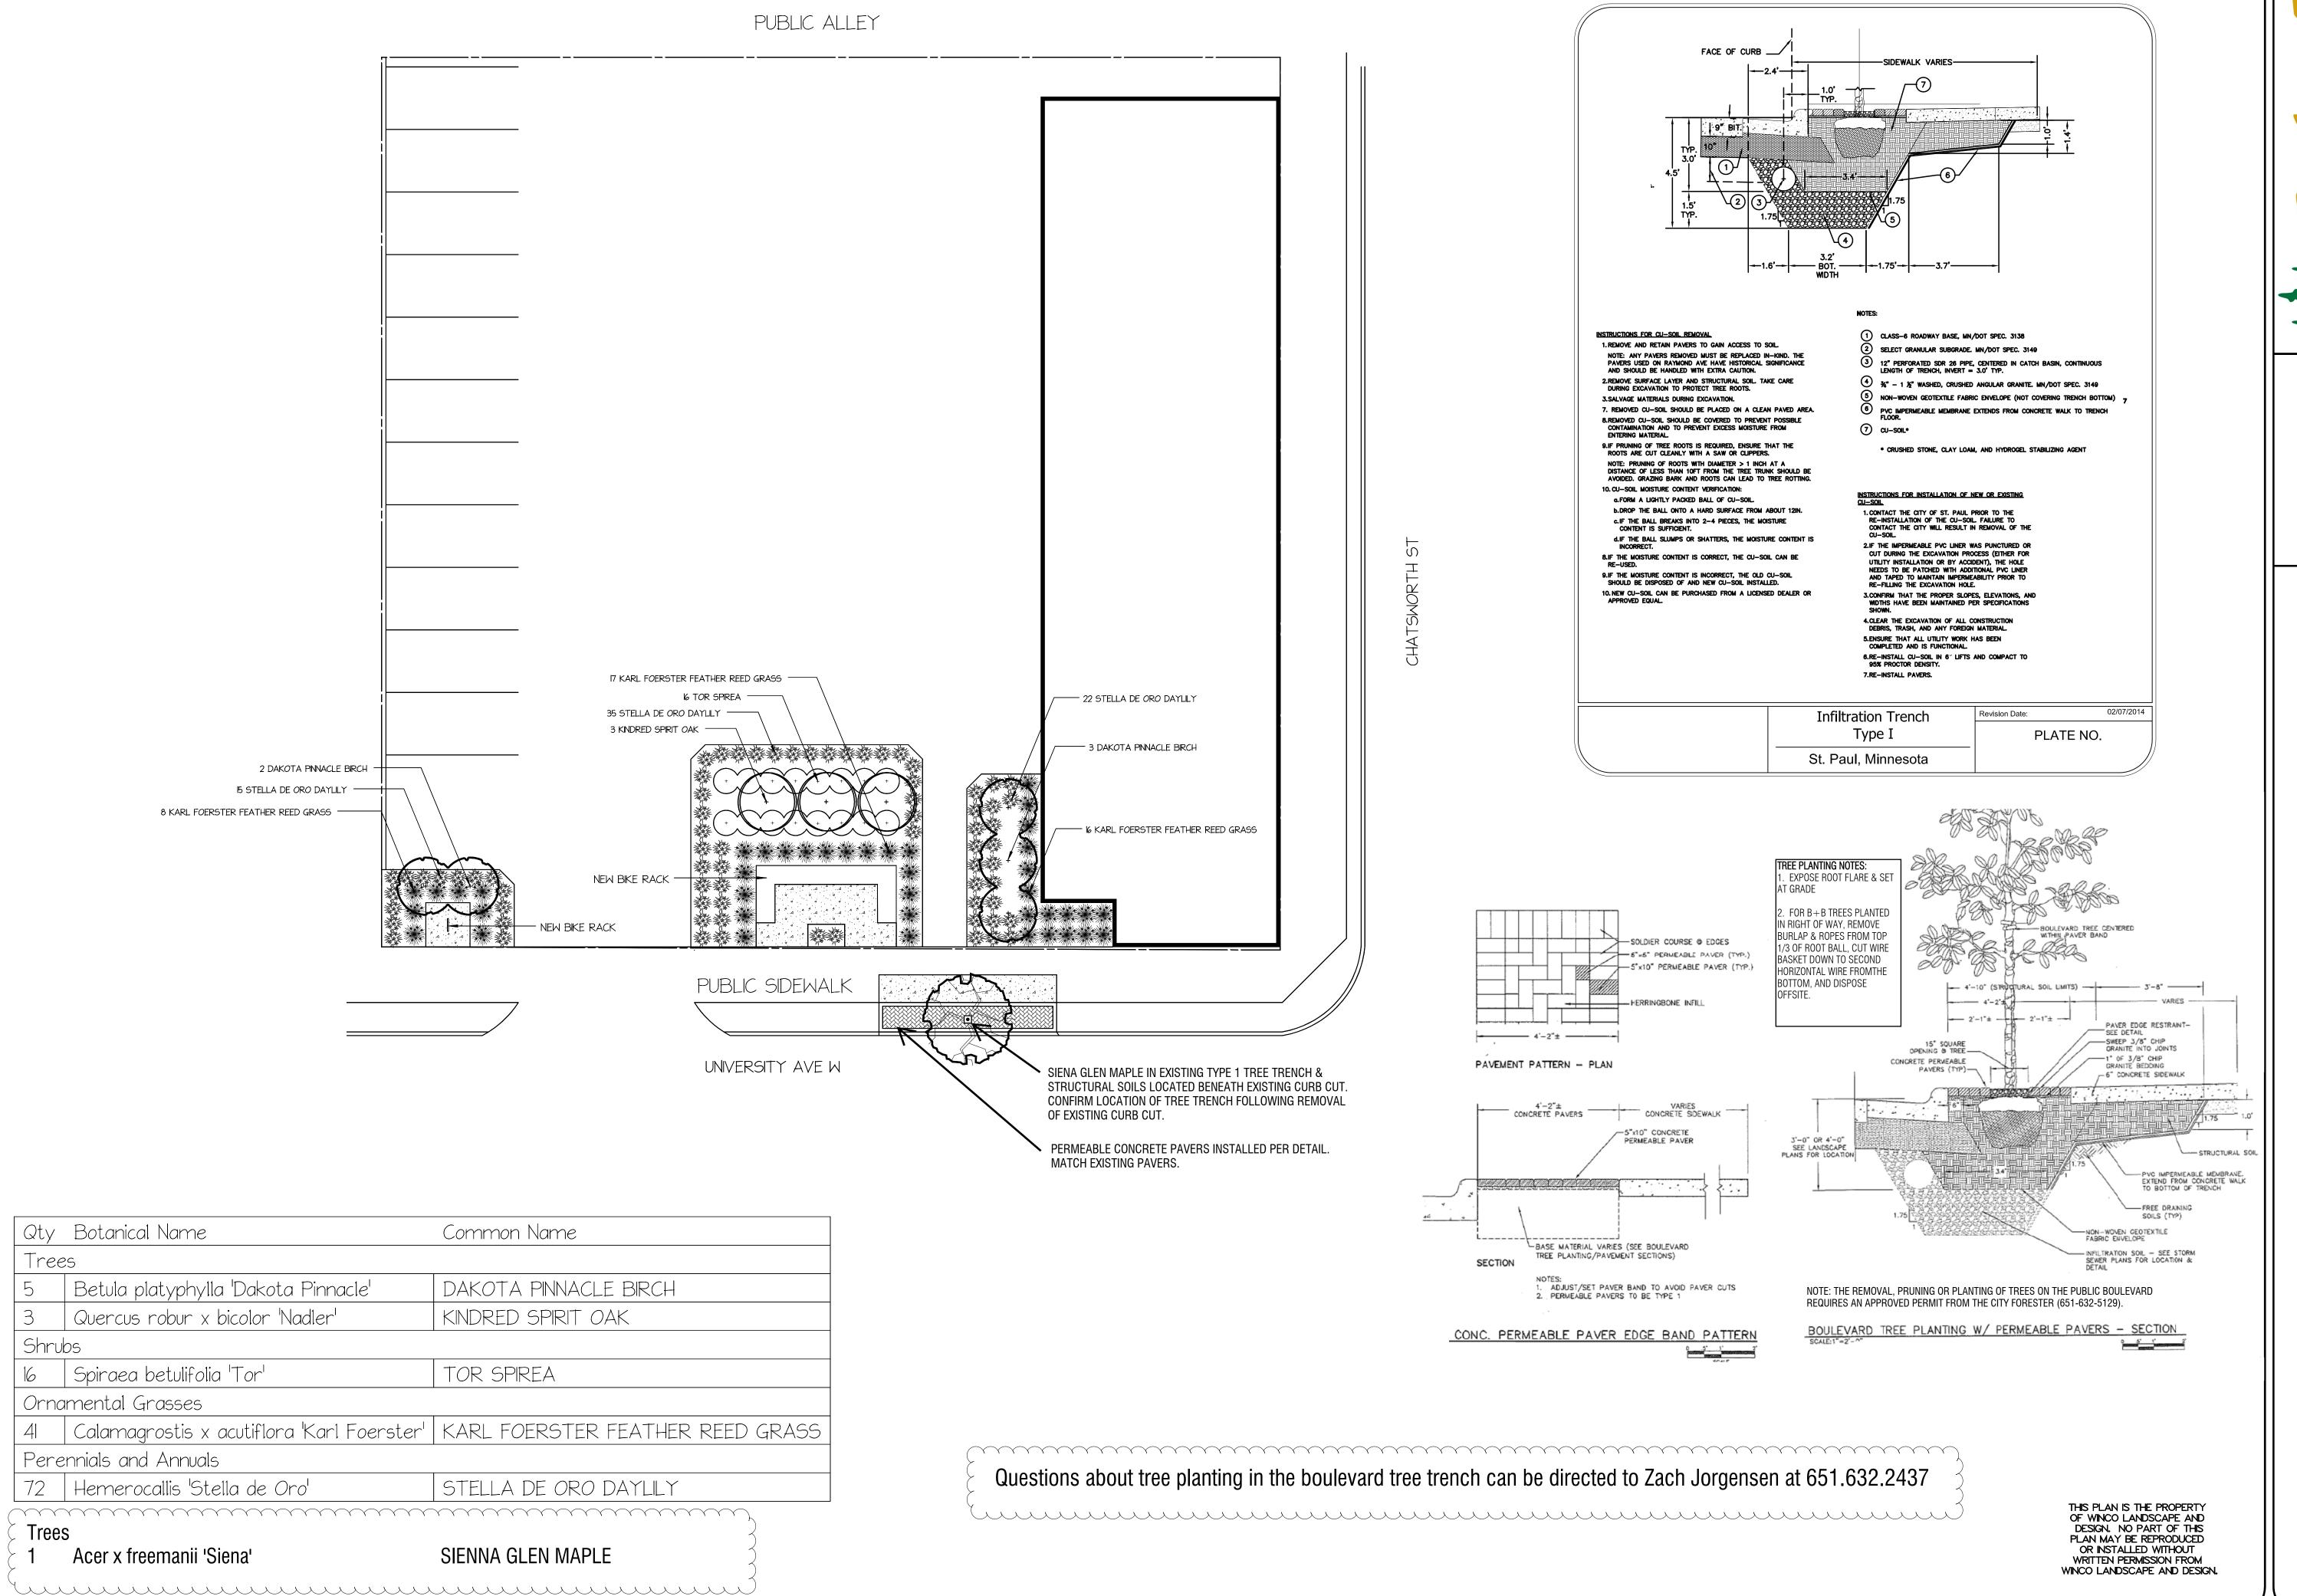

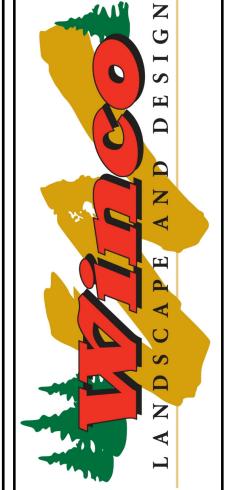

NORTH

PARKLET NIVERSITY

 $\bigcirc$ Revision 2 09/08/16 

L001

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