

SITE LEASE AGREEMENT

**Between Board of Water Commissioners of the City of Saint Paul and
Sprint Spectrum L.P.**

This Lease Agreement ("Lease") is entered into this _____ day of _____, 2017, between the **BOARD OF WATER COMMISSIONERS OF THE CITY OF SAINT PAUL**, a Minnesota municipal corporation ("Lessor"), and **SPRINT SPECTRUM L.P.**, a limited partnership organized and existing under the laws of Delaware, ("Lessee").

In consideration of the terms and conditions of this Lease, the parties agree as follows:

1. Leased Premises.

(a) Lessor hereby leases to Lessee certain space located at and on Lessor's Cottage Avenue Standpipe, located at 2095 Clear Ave E, Saint Paul, MN, and legally described in Exhibit "A" *Legal Description*. The water storage facility and its appurtenances ("Structure"), and the Lessor's land upon which the Structure is situated are collectively called ("the Property"). The property interest leased and granted by the Lessor to Lessee (collectively, the "Leased Premises") consists of the following:

- (1) ground space comprised of approximately _____ square feet, subject to any and all existing easements;
- (2) structure exterior space for attachment of antennas at alpha, beta & gamma sectors at _____ FAGL;
- (3) space required for cable runs to connect equipment and antennas;
- (4) non-exclusive easements required to run utility lines and cables;
- (5) non-exclusive easement across the Property for access.

(b) No other space or property interests are being leased to Lessee except as described above and as described on Exhibit "A" *Legal Description*.

2. Terms/Renewals.

(a) The initial term of this Lease shall commence on April 01, 2017 (the "Commencement Date"), and shall expire on December 31, 2022. Lessee and Lessor agree to enter into a

memorandum confirming the Commencement Date, as contained in Exhibit "F"
Memorandum of Lease Recording.

- (b) Lessee shall have the right to extend this Lease for three (3) additional five (5) year terms (each a "Renewal Term") subject to (c) below.
- (c) This Lease shall automatically be renewed for each successive Renewal Term unless Lessee is in default beyond applicable notice and cure periods of any of the terms or conditions of this Lease, or unless Lessee provides Lessor with written notice of its intention not to renew not less than thirty (30) days prior to commencement of the succeeding Renewal Term.

3. Rent.

- (a) Lessee shall make all payments of rent to Lessor at the following address or until otherwise notified of a change in address:

Board of Water Commissioners
Attn: SPRWS Accounting
1900 Rice Street, Office Building
Saint Paul, Minnesota 55113

- (b) Lessor's FIN number is # 41-6005521.
- (c) Lessee shall pay rent annually in advance, as indicated in the payment schedule below:
 - (1) Lessee shall pay Lessor, as rent, the sum of \$46,650.00 per year plus annual escalator described in Section 3(c)(4) based upon Lessee's installation and operation of the antenna facilities and frequencies identified in Exhibit "D" *Antenna Facilities and Frequencies*, ("Antenna Facilities").
 - (2) The first year's rent shall be pro-rated to the end of 2017 based on the Commencement Date for year 2017, and shall include a one-time administrative fee of Two Thousand Five Hundred Dollars (\$2,500.00), and shall be paid within sixty (60) days after the Commencement Date. Thereafter, the rent due hereunder shall be paid on or before the fifth (5th) day of each January of each succeeding year.
 - (3) Lessee shall not install and/or operate any additional antennas or related equipment beyond those Antenna Facilities and frequencies identified in Exhibit "D" *Antenna Facilities and Frequencies* without the prior written consent of Lessor, such consent not to be withheld, conditioned or delayed without cause. Such additional equipment may require an amendment to the Lease and increase in rent, as may be determined by Lessor. However, changes made exclusively to frequencies shall not require an amendment and shall not constitute grounds for revision of rent. Notwithstanding, Lessee has the right to perform routine maintenance and repairs without Lessor's approval.

- (4) Commencing January 1, 2018, and on January 1st of each subsequent year, the rent shall be increased annually by five percent (5%).

4. Engineering Studies

(a) Structural Study

Prior to modifying the existing Antenna Facilities to increase the weight load on the Structure, Lessee must obtain an engineering study carried out by a qualified engineer, showing that the Structure is able to support the additional Antenna Facilities. If the study finds that the Structure is inadequate to support the proposed antenna loads, Lessee may not perform such modifications unless Lessee agrees to make structural modifications to the Structure in order to support the additional load.

(b) Interference Study

Prior to modifying the existing antennas or frequencies at the Leased Premises, Lessee must obtain a radio frequency interference study carried out by an independent professional radio frequency engineer (“RF Engineer”) showing that Lessee’s intended use will not interfere with any existing communications facilities located on the structure. RF Engineer shall provide said evaluation no later than thirty (30) days after frequencies are provided by Lessee. Lessee shall provide Lessor with a copy of a satisfactorily completed RF evaluation prior to transmitting or receiving radio waves at the Property.

5. Use of Leased Premises.

(a) Primary Use of Property

The primary use and purpose of the Property, including the Leased Premises, is for a water storage structure and appurtenances to provide water service to customers of the Lessor (“Primary Use”). Lessor’s operations in connection with pursuit of the Primary Use (“Lessor’s Operations”) take priority over Lessee’s operations.

(b) User priority

Lessee agrees that the following priorities of use, in descending order, shall apply in the event of communication interference, emergency public safety needs, or other conflict while this Lease is in effect, and Lessee’s use shall be subordinate accordingly:

- (1) Lessor;
- (2) Public safety agencies, including law enforcement, fire, and ambulance services, that are not related to Lessor;
- (3) Other governmental agencies where use is not related to public safety;
- (4) Pre-existing lessees (defined as lessees that installed equipment prior to Lessee’s original installation of equipment on September 19, 1996);
- (5) Lessee.

(c) Jeopardy of Primary Use

- (1) In the event that the Lessor's Primary Use of the Structure is put at risk because of Lessee's operations ("Jeopardy"), Lessor shall provide written notice of such event to Lessee. Lessor and Lessee agree to work together to cure the occurrence that causes the Jeopardy. Lessee shall make all good efforts to cure the Jeopardy within thirty (30) days of receipt of written notice of event. If Lessee does not cure the Jeopardy within thirty (30) days of receipt of written notice of event, said occurrence of Jeopardy shall constitute an event of default by Lessee, as otherwise defined in *Section 14. Termination*. If circumstances beyond the control of Lessee prohibit the Jeopardy from reasonably being cured within thirty (30) days, Lessee shall notify Lessor of such circumstances and commence actions required to cure the Jeopardy (e.g. assessing the problem, ordering necessary equipment) within seven (7) days of Lessor's written notice of Jeopardy and shall diligently pursue the cure to completion within a reasonable time thereafter.
- (2) In the event of Jeopardy that poses an immediate threat of substantial harm or damage to the water supply, to persons, and/or property on the Leased Premises, as solely determined by Lessor ("Severe Jeopardy"), Lessor may enter the Leased Premises and take actions it determines are required to protect the water, individuals or personal property from such Severe Jeopardy; provided that promptly after such emergency entry onto the Leased Premises, and in no event later than twenty-four (24) hours after such entry, Lessor gives written notice to Lessee of Lessor's emergency entrance.
- (3) If Lessor determines that the conditions of a Severe Jeopardy would be benefited by cessation of Lessee's operations, Lessee shall immediately cease its operations on the Premises upon notice from Lessor to do so and Lessee shall be permitted to terminate this Lease upon written notice to Lessor.

(d) Lessee's Use of Leased Premises

- (1) Lessee shall have the non-exclusive right, at its sole cost and expense, to use the Leased Premises for the transmission and reception of communications signals ("Approved Use").
- (2) In accordance with this Approved Use, the Lessee has the right to install, operate, maintain, repair, replace, store or remove its antennas, utility building, equipment, personal property, leasehold improvements, and appurtenances as shown in Exhibit "D" *Antenna Facilities and Frequencies* and Exhibit "C" *Construction Plans*.
- (3) Lessee shall be responsible for all expenses incurred by the Lessor resulting directly from the use and/or occupancy of the Leased Premises by Lessee. Lessor shall submit an itemized invoice of such expenses to Lessee together with reasonable supporting documentation evidencing such expenses at the notice address set forth in Section 17 below and Lessee shall make payment to Lessor within sixty (60) days of receipt.

(e) Laws Governing Use

Lessee's Antenna Facilities and any other facilities shall be installed, maintained, and operated in accordance with all state or federal or local or municipal statutes, ordinances, rules, or regulations now in effect, or that hereafter may be issued by the Federal Communications Commission ("FCC") or any other governing bodies which apply to Lessee's Approved Use of the Leased Premises.

6. Installation of Equipment and Leasehold Improvements.

(a) **Construction Plans**

For the initial installation of all Antenna Facilities and for any and all subsequent revisions and/or modifications thereof, or additions thereto, Lessee shall provide Lessor and Lessor's Water Tower Construction Engineer ("Construction Engineer") each with comprehensive construction plans ("Construction Plans") consisting of the following:

- (1) line or CAD drawings showing location of all planned installations plus materials and construction methods;
- (2) specifications for all planned installations;
- (3) diagrams of Antenna Facilities for initial installation, and subsequently, diagrams of proposed antenna facilities for any and all revisions, modifications, or approved additions;
- (4) a complete and detailed inventory of all proposed equipment and personal property of Lessee to be placed on the Leased Premises. Lessor retains the right, at its sole cost and expense, to survey such equipment and personal property.

(b) Construction Plans shall be easily readable and subject to prior written approval by the Construction Engineer, which shall not be withheld, conditioned or delayed without cause. Lessor shall have thirty (30) business days to review and comment on the Construction Plans. Lessor, on behalf of itself and the Construction Engineer, hereby approves of the Construction Plans for the existing Antenna Facilities.

(c) Lessee shall be solely responsible for all costs associated with said review and approval of Construction Plans by Construction Engineer ("Review Fee") for the review of the Construction Plans for each subsequent revision, modification, or approved addition to the Antenna Facilities.

(d) **Construction Scheduling**

At least five (5) days prior to Lessee's construction mobilization, Lessee shall conduct a pre-construction meeting on the Property or other location as determined by Lessor. Said meeting shall be attended by the Construction Engineer, Lessee's representative and all contractors involved in the installation.

(e) **Construction Inspection.**

All construction activity for any and all subsequent revisions and/or modifications to the Antenna Facilities, or additions thereto shall be subject to inspection and approval by the

Construction Engineer to ensure compliance with the approved Construction Plans and the terms of this Lease. Inspection will be performed beginning with the pre-construction meeting and continuing through installation/construction/punch-list and verification of as-built drawings at project completion as determined by Lessor. Lessee agrees to pay for the cost of said inspections and project documentation (“Inspection Fees”). Lessor shall submit an itemized invoice of such Inspection Fees to Lessee at the notice address set forth in Section 17 below together with reasonable supporting documentation evidencing such fees and Lessee shall make payment to Lessor within sixty (60) days of receipt. If deemed necessary by the Construction Engineer, construction work performed without approval of the Construction Engineer will not be accepted and shall be removed or uninstalled at Lessee’s sole expense, provided Lessor or the Construction Engineer notifies Lessee of such non-compliance within thirty (30) days of submission of as-built drawings to Lessor.

(f) Escrow

Prior to performing subsequent revisions and/or modifications to the existing Antenna Facilities or additions thereto, Lessee agrees to pay an escrow amount equal to the estimated costs of Review Fees and Inspection Fees as determined by Lessor for any and all such subsequent revisions and/or modifications thereof, or additions thereto, prior to commencement of such activities. If the escrow amount is insufficient for these expenses, Lessee agrees to pay the additional costs within forty-five (45) days of receipt of a detailed invoice from Lessor at the notice address set forth in Section 17 below together with reasonable supporting documentation evidencing such costs.

(g) Exposed Antenna Facilities

All Antenna Facilities and coaxial cables affixed to the Structure which have exterior exposure shall be as close to the color of the Structure as is commercially available to the Lessee. For exposed coaxial cables that Lessee desires to install after the Commencement Date of this Agreement, Lessor reserves the right to require Lessee to provide cables in manufactured colors in lieu of painting.

(h) Damage by Lessee

Any damage to the Property, Leased Premises, or Lessor’s equipment thereon caused by Lessee’s installation or operations shall be repaired or replaced at Lessee’s expense and to Lessor’s reasonable satisfaction.

(i) As-built drawings

Within thirty (30) days after Lessee activates the Antenna Facilities, Lessee shall provide Lessor with a Site Plan in electronic file format compatible with Lessor’s record file system consisting of as-built drawings of the Antenna Facilities and the improvements installed on the Property, which shall show the actual location of all equipment and improvements. Said drawings shall be accompanied by a complete and detailed site survey of the property, inventory of all equipment, personal property, and Antenna Facilities.

7. Modifications.

- (a) Before the Lessee may update or replace the Antenna Facilities, Lessee must provide a detailed proposal to Lessor. The proposal shall include any information reasonably requested by Lessor of such requested update or replacement, including but not limited to revised lease exhibits as may be necessary, construction drawings and specifications as may be required under *Section 6. Installation of Equipment and Leasehold Improvements*, and engineering studies as may be required under *Section 4. Engineering Studies* of this Lease, carried out at Lessee's expense. The proposal must be approved by Lessor, which will not unreasonably withhold approval.
- (b) Lessee shall provide at least thirty (30) days written notice to Lessor before modifying frequencies on the Leased Premises. Said notice shall describe all equipment and frequencies proposed to be added or modified and shall be subject to evaluation by a RF Engineer approved by Lessor, which shall not be withheld, conditioned or delayed without cause. Said review shall consist of necessary interference studies to ensure that the modified or additional frequencies will not cause harmful radio interference to Lessor's Operations or the operations of Lessor's existing tenants. Lessee shall pay all costs for any such interference studies. In the alternative, Lessee may perform the interference studies and submit the results to the Lessor for review and approval.
- (c) If Lessee seeks to increase the number of antennas and/or associated transmitting accessories, and such installation shall exceed the requirements or standard discussed in the engineering report as required by Section 4.(a), then Lessee must obtain an engineering study carried out by a qualified professional demonstrating that the Structure can structurally support the additional accessories.
- (d) As-built drawings
Within thirty (30) days after Lessee activates the Antenna Facilities, Lessee shall provide Lessor with a Site Plan in electronic file format compatible with Lessor's record file system consisting of as-built drawings of the Antenna Facilities and the improvements installed on the Property, which shall show the actual location of all equipment and improvements. Said drawings shall be accompanied by a complete and detailed site survey of the property, inventory of all equipment, personal property, and Antenna Facilities. By its signature below, Lessor acknowledges receipt of the foregoing Site Plan, site survey and inventory in the form required by this Section.

8. Maintenance and Repairs.

- (a) Property
 - (1) Lessor reserves the right to take any action it deems necessary, in its sole and reasonable discretion, to repair, maintain, alter, or improve the Property in connection with Lessor's Operations.
 - (2) Lessor agrees to provide Lessee with thirty (30) days advance notice of such actions that may directly affect Lessee's operations, and to reasonably cooperate with

Lessee to carry out such activities in a manner that minimizes interference with Lessee's Approved Use.

(b) Structure Reconditioning and Repairs

- (1) From time to time, Lessor paints, reconditions, or otherwise improves or repairs the Structure in a substantial way ("Reconditioning Work"). Lessor shall reasonably cooperate with Lessee to carry out Reconditioning Work activities in a timely manner and in a manner that minimizes interference with Lessee's Approved Use.
- (2) Prior to commencing Reconditioning Work, Lessor shall provide Lessee with not less than ninety (90) days prior written notice thereof. Upon receiving such notice, it shall be the sole responsibility of Lessee to provide adequate measures to cover or otherwise protect Lessee's Antenna Facilities from the consequences of such activities, including but not limited to paint and debris fallout. Lessor reserves the right to require Lessee to temporarily remove all Antenna Facilities from the Structure and Leased Premises during Reconditioning Work.
- (3) During Lessor's Reconditioning Work, Lessee may maintain a mobile site on the Property or, after approval by Lessor, on any land owned or controlled by Lessor in the immediate area of the Property. If Property will not accommodate mobile equipment, it shall be Lessee's responsibility to locate auxiliary sites.
- (4) Lessee may request a modification of Lessor's procedures for carrying out Reconditioning Work in order to reduce the interference with Lessee's Approved Use. If Lessor agrees to the modification, Lessee shall be responsible for all incremental cost related to the modification.

(c) Leased Premises

Lessee shall, at its own cost and expense, maintain the Antenna Facilities in good and safe condition, and in compliance with applicable fire, health, building, and other life safety codes applicable to Lessee's Approved Use of the Leased Premises.

9. Property Access.

Access to the Property, including the Leased Premises, by outside persons, including Lessee's employees, agents and assigns, shall at all times be governed by Lessor's Security Plan, as may be revised from time to time and provided to Lessee in writing, in advance, with the most recent Plan being attached hereto and incorporated herein as Exhibit "E" *Security Plan*. Lessee agrees it shall conduct its operations on the Property and the Leased Premises in accordance with all requirements and conditions of said Security Plan. Subject to said requirements and conditions of said Security Plan, Lessee and Lessor agree to the following:

- (a) At no additional charge to Lessee, Lessee shall have access to the Leased Premises and Property, for any purpose relating to this Lease, twenty-four (24) hours a day, seven (7) days a week by means of existing access, as shown on Exhibit "B" *Site Survey*.

- (b) Lessee may, at its own cost and expense, enter upon the Property to study and determine the Property's suitability for any other use of Lessee, which studies may include surveys, radio wave propagation measurements, or field strength tests.
- (c) Lessor retains the right to examine and inspect the Leased Premises for safety reasons and to ensure Lessee's compliance with the terms of this Lease. Lessor shall be liable for, and hold harmless Lessee from, any damage to the Leased Premises or to Lessee's equipment and Antenna Facilities caused by Lessor in exercising its right to examine and inspect the Leased Premises.
- (d) At Lessee's sole cost and expense, Lessee has the right to obtain a title report or commitment for a leasehold time policy from a title company of its choice and to have the Property surveyed by a surveyor of its choice.

10. Utilities.

Lessor makes no representations that utilities adequate for Lessee's use of the Leased Premises are available. Lessee shall be responsible for the cost of all utilities installed and used by it at the Leased Premises. Lessor will cooperate with Lessee in Lessee's efforts to obtain utilities from any location provided by the servicing utility.

11. Personal Property and Real Estate Taxes.

If any of Lessee's improvements constructed on the Leased Premises should cause the Property, or any portion of it, to be taxed for real estate purposes, it shall be the liability of Lessee to pay that portion of such property taxes directly attributable to Lessee's equipment, provided Lessor shall give Lessee prior written notification of such taxes so that Lessee will have the opportunity to appear before the taxing authority to contest such taxes. Notwithstanding Lessee's right to contest such taxes, Lessee shall pay its share of such taxes within ninety (90) days of receiving notice of the same.

12. Certificates, Permits, Zoning, and other Approvals.

Lessee's use of the Leased Premises herein is contingent upon its obtaining all certificates, permits, zoning, and other approvals that may be required by any federal, state or local authority, including but not limited to an engineering study and a radio frequency interference study. Lessee shall, at its sole cost and expense, obtain all such necessary permits, licenses and other approvals and Lessor agrees to cooperate with Lessee in Lessee's pursuit of all such necessary permits, licenses or approvals, and Lessee shall reimburse Lessor its reasonable costs to provide such cooperation.

13. Interference.

- (a) In the performance of its Approved Use, Lessee shall not damage or interfere with Lessor's Operations, including its radio frequency transmissions, or approved operations of other parties that were in place on the Property prior to the Commencement Date of this Lease, provided that the equipment used by Lessor or other lessees is operating

within the technical parameters specified by its manufacturer and/or as defined by the FCC. In the event of any such interference, Lessee shall immediately cease such interference, except for brief tests necessary for the elimination of the interference and until Lessee is able to resolve the problem. In the event Lessee cannot correct the interference, Lessee shall have the option to terminate this Lease, pursuant to *Section 14. Termination*. Lessee shall not be responsible for interference that results from a change in the operations of other tenants after the Commencement Date of this Lease.

- (b) Lessee acknowledges that Lessor may lease the Property, or any part of it, to other parties in close proximity to the Leased Premises, and Lessee agrees to work cooperatively with any such other parties, using accepted technical standards in accordance with FCC standards, to ensure that such other parties' use and Lessee's use will be compatible and will not cause interference with each other.
- (c) Lessor in no way guarantees to Lessee noninterference with Lessee's transmission operations provided, however, that in the event that any other party requests permission to place any type of additional antenna or transmission facility on the Property, the procedures of this Section shall govern to determine whether such antenna or transmission facility will interfere with Lessee's transmission operations.
- (d) In the event that Lessee or other tenants on the Property experience interference of their FCC-approved frequencies and they cannot reach agreement as to the cause and remedy of such interference, an RF Engineer approved by the Lessor shall determine such cause and remedy and Lessee shall abide by the RF Engineer's determination, subject to Lessee's right to terminate this Lease.

14. *Termination.*

- (a) Except as provided for in Section 14.(a)(3)b. below, or as otherwise provided herein, this Lease may be terminated by either party upon sixty (60) days written notice to the other party for the following reasons:
 - (1) By either party, upon a material default of any other covenant or term hereof by the other party; which default is not cured within sixty (60) days of receipt of written notice of default to the other party (without, however, limiting any other rights of the parties at law, in equity, or pursuant to any other provisions hereof), or if such cure cannot be completed within sixty (60) days, within such reasonable time as may be required, provided the defaulting party commences the cure within ten (10) days of receipt of written notice of default and diligently pursues such cure to completion;
 - (2) By Lessee, in the event that:
 - a. Lessee is unable to obtain or maintain any license, permit, or other governmental approval necessary for the construction and/or operation of the Antenna Facilities;
 - b. the Leased Premises are or become unusable under Lessee's design or engineering specifications for its Antenna Facilities, or the communications system to which the Antenna Facilities belong; or

- c. Lessee's transmission is interfered with by Lessor or its other tenants' equipment. Such right to terminate shall become void if Lessor cures such interference within thirty (30) days of receipt of written notice.
- d. If the Property or any portion thereof is destroyed or damaged so as to hinder its effective use, Lessee may elect to terminate this Lease upon thirty (30) days written notice to Lessor. In such event, all rights and obligations of the parties shall cease as of the date of the damage or destruction and Lessee shall be entitled to the reimbursement of any rent prepaid by Lessee, prorated to the date of the event.

(3) By Lessor, in the event that:

- a. Lessor determines, after review by an independent structural engineer, that the Property is structurally unsound, including but not limited to consideration of age of the Structure, damage or destruction of all or part of the Property from any source, or factors relating to condition of the Property;
 - b. Lessee fails to pay rent provided for in *Section 3. Rent* within thirty (30) days of receipt of written notice from Lessor of a rent payment being overdue; or
 - c. Lessee does not complete installation of its Antenna Facilities as shown on Exhibit "D" *Antenna Facilities and Frequencies* within one (1) year of the Commencement Date of this Lease.
 - d. Upon 120 days prior written notice by the Lessor to Lessee if Lessor decides, for any reason, to redevelop and/or discontinue use of the Leased Premises in a manner inconsistent with continued use of the Leased Premises by Lessee.
- (b) If this Lease is terminated, pursuant to the terms and conditions of Section 14.(a), rent shall be pro-rated to the expiration date or the date on which all of Lessee's equipment is removed from the Leased Premises and the Property is restored pursuant to *Section 23. Surrender of Leased Premises*, whichever is later.
- (c) If Lessee terminates this Lease other than provided for in Section 14.(a), Lessee shall pay to Lessor a termination fee in the amount of twenty-five percent (25%) of the rent for the year in which Lessee terminates, unless Lessee terminates during the last year of any Term under *Section 2. Terms/Renewal* and Lessee has paid the rent for that year.
- (d) In the event Lessee becomes aware of any hazardous materials on the Property, or any environmental, health or safety conditions or matter relating to the Property, that, in Lessee's sole determination, renders the condition of the Leased Premises or Property unsuitable for Lessee's use, or if Lessee believes that the leasing or continued leasing of the Leased Premises would expose Lessee to undue risks of liability to a government agency or third party, Lessee will have the right, in addition to any other rights it may have at law or in equity, to terminate this Lease upon written notice to Lessor specifically identifying all such materials, conditions or matters relating to the Property.

15. Insurance.

(a) Lessee shall obtain and maintain the following insurance to protect the parties against insurable claims, demands, actions, judgments, expenses, and liabilities that may arise out of or result from Lessee's use of the Leased Premises:

(1) General Liability Insurance

- a. Bodily Injury \$1,500,000 each occurrence
 \$3,000,000 aggregate
- b. Property Insurance \$1,500,000 each accident
 \$3,000,000 aggregate
- c. These limits may be satisfied by the commercial general liability coverage or in combinations with an umbrella or excess liability policy, provided coverage afforded by the umbrella or excess policy are no less than the underlying commercial general liability coverages.
- d. Policy must include an "all services, products, or completed operations" endorsement. Lessee shall maintain Completed Operations coverage for a minimum of two years after the construction is completed.

(2) Automobile Insurance

- a. Bodily Injury \$1,000,000 per person
 \$1,500,000 per accident
- b. Property damage not less than \$1,500,000 per accident
- c. The liability limits may be afforded under the Commercial Policy, or in combination with an umbrella or excess liability policy provided coverages of rides afforded by the umbrella or excess policy are not less than the underlying Commercial Auto Liability coverage.
- d. The Commercial Automobile Policy shall include at least statutory personal injury protection, uninsured motorists and under insured coverages.
- e. Coverage shall be provided by Bodily Injury and Property Damage for the ownership, use, maintenance or operation of all owned, non-owned and hired automobiles.

(3) Workers' Compensation and Employer's Liability

- a. Workers' Compensation per Minnesota Statute
- b. Employer's Liability shall have minimum limits of:
 - 1. \$500,000 per accident;
 - 2. \$500,000 per employee
 - 3. \$500,000 per disease policy limit
- c. Lessees with 10 or fewer employees who do not have Workers' Compensation coverage are required to provide a completed "Certificate of Compliance" (State

of Minnesota form MN LIC 04) verifying the number of employees and the reason for their exemption.

- (b) Lessee shall provide Lessor, prior to the Commencement Date and, and annually thereafter prior to expiration date of the same, evidence of the required insurance in the form of a certificate of insurance issued by an insurance company licensed to do business in the State of Minnesota, which includes all coverage required in Section 15.(a) above.
- (c) Policies are to be written on an occurrence basis or as acceptable to the Lessor. Certificate of Insurance must indicate if the policy is issued on a claims-made (if expressly approved by Lessor) or occurrence basis. All certificates of insurance shall provide that Lessor shall be given notice of cancellation in accordance with the policy's terms and conditions.
- (d) Additional Insured – Certificate of Insurance. The Lessee shall provide, prior to tenancy, evidence of the required insurance in the form of a Certificate of Insurance issued by a company (rated A- or better by Best Insurance Guide) licensed to do business in the state of Minnesota, which includes all coverage required in this *Section 15. Insurance*. General Liability and Automobile policies shall include the Lessor and the City of Saint Paul as additional insured, and shall provide that it will be the primary coverage.

16. Indemnity.

Lessee agrees to indemnify, defend, save, and hold harmless Lessor and the City of Saint Paul, and/or any agents, officers or employees thereof from all claims, demands, actions, or causes of action of whatsoever nature or character, arising out of, or by reason of, the leasing of the Leased Premises by the Lessor to Lessee, or arising out of, or by reason of, the use or condition of the Leased Premises, or as a result of Lessee's operations or business activities taking place on the Leased Premises or Lessee's breach of any provision of this Lease, provided the same is not due to the contributory negligence or willful misconduct of the Lessor, the City of Saint Paul and/or any agents, contractors, officers, or employees thereof. It is fully understood and agreed that Lessee is aware of the conditions of the Leased Premises and leases the same "as is".

17. Notices.

All notices, requests, demands, and other communications hereunder shall be in writing and shall be deemed to have been duly given (a) when delivered in person, (b) upon receipt after dispatch by registered or certified mail or (c) on the next Business Day if transmitted by national overnight courier (with confirmation of delivery) to the following addresses:

If to Lessor: Board of Water Commissioners
 Attn: General Manager
 1900 Rice Street, Office Building
 Saint Paul, Minnesota 55113

If to Lessee, to: Sprint Property Services
 Sprint Side ID: MS03XC472

Mailstop KSOPHT0101-Z2650
6391 Sprint Parkway
Overland Park, Kansas 66251-2650

With copy to: Sprint Law Department
Sprint Site ID: MS03XC472
Mailstop KSOPHT0101-Z2020
6391 Sprint Parkway
Overland Park, Kansas 66251-2020
Attn.: Real Estate Attorney

18. Representations and Warranties.

- (a) Lessor represents that (i) it has full right, power, and authority to execute this Lease; (ii) it has good and unencumbered title to the Property free and clear of any liens or mortgages, subject to such liens of record; (iii) Lessee shall have quiet enjoyment of the Leased Premises during the term of this Lease in accordance with its terms.
- (b) Lessee warrants that the individuals signing and executing this Lease on behalf of Lessee have the requisite corporate power and authority to enter into and perform this Lease on behalf of Lessee. Lessor warrants that the individuals signing and executing this Lease on behalf of Lessor have the requisite corporate power and authority to enter into and perform this Lease on behalf of Lessor.
- (c) Lessor represents that it has no knowledge of any substance, chemical or waste on the Property that is identified as hazardous, toxic or dangerous in any applicable federal, state or local law or regulation, as defined in Section 18.(d) of this Lease. Lessor will be solely liable for and will defend, indemnify and hold Lessee, its agents and employees harmless from and against any and all direct claims, costs and liabilities, including reasonable attorneys' fees and costs, arising out of or in connection with the removal, cleanup or restoration of the Property with respect to hazardous, toxic or dangerous materials from any and all sources other than those hazardous, toxic or dangerous materials introduced to the Property by Lessee. Lessee represents and warrants that its use of the Leased Premises herein will not generate and it will not store or dispose on the Property nor transport to or over the Property any hazardous substance, chemical or waste contrary to any applicable law or regulation. Lessee further agrees to hold Lessor harmless from and indemnify Lessor against any release of any such hazardous substance, and any damage, loss, expense, or liability resulting from the breach of this representation or from the violation of any applicable state or federal law by such release associated with Lessee's use of hazardous substances, including payment of all reasonable attorneys' fees, costs, and penalties incurred as a result thereof, except for any release caused by the negligence or willful misconduct of Lessor, its employees, or agents.
- (d) "Hazardous substance" shall be interpreted broadly to mean any substance or material defined or designated as hazardous or toxic waste, hazardous or toxic material, hazardous

or toxic or radioactive substance, or other similar term by any federal, state, or local environmental law, regulation or rule presently in effect or promulgated in the future, as such laws, regulations, or rules may be amended from time to time. Lessor acknowledges Lessee's use of batteries as back-up power and deems them acceptable as long as such batteries are used and disposed of in accordance with all applicable laws.

19. No Liability on Lessor.

Except due to Lessor's willful misconduct or negligence, Lessor shall not be liable for any damage to Lessee's equipment or Antenna Facilities, and Lessor shall not be liable for vandalism or malicious mischief caused by third parties, known or unknown, to Lessee's equipment or facilities, nor shall Lessor be liable for any lost revenue, business or profits of Lessee.

20. Assignment.

- (a) This Lease may be sold, assigned or transferred by Lessee without approval or consent of Lessor to Lessee's principal, affiliates, subsidiaries of its principal or to any entity which acquires all, or substantially all, of Lessee's assets in the market defined by the FCC in which the Property is located by reason of a merger, acquisition or other business reorganization. Lessee shall provide Lessor written notice of any such sale, assignment or transfer within sixty (60) days after the effective date thereof. As to other parties, this Lease may not be sold, assigned or transferred without the written consent of Lessor, which such consent shall not be unreasonably withheld, delayed or conditioned. No change of stock ownership, partnership interest or control of Lessee or transfer upon partnership or corporate dissolution of Lessee shall constitute an assignment hereunder.
- (b) The parties acknowledge that this is a nonexclusive lease. Nothing in this Lease shall preclude Lessor from leasing other space on the Property to any other person or entity which may be in competition with Lessee, or any other party, subject to the conditions set forth in *Section 13. Interference*.

21. Condemnation.

Lessor shall provide to Lessee notice of any condemnation proceedings within thirty (30) business days of receipt. In the event the whole of the Leased Premises is taken by eminent domain, this Lease shall terminate as of the date title to the Leased Premises vests in the condemning authority. In the event a portion of the Leased Premises is taken by eminent domain, either party shall have the right to terminate this Lease as of said date of title transfer, by giving thirty (30) days written notice to the other party. In the event of any taking under the power of eminent domain, Lessee shall not be entitled to any portion of the reward paid for the taking and the Lessor shall receive full amount of such award. Lessee hereby expressly waives any right or claim to any portion thereof. Although all damages, whether awarded as compensation for a decrease in value of the leasehold or to the fee of the Leased Premises, shall belong to Lessor, Lessee shall have the right to claim and recover from the condemning authority, but not from Lessor, such compensation as may be separately awarded or recoverable by Lessee on account of any and all damage to Lessee's business and

any costs or expenses incurred by Lessee in moving/removing its equipment, personal property, Antenna Facilities, and leasehold improvements.

22. Successors and Assigns.

This Lease shall run with the Property. This Lease shall be binding upon and inure to the benefit of the parties, their respective successors and assigns.

23. Surrender of Leased Premises.

- (a) All portions of the Antenna Facilities brought onto the Property by Lessee will be and remains Lessee's personal property and, at Lessee's option, may be removed by Lessee at any time during or after the term or extension thereof. In the event that this Lease is terminated or not renewed, Lessee shall have sixty (60) days from the termination or expiration date to quit peacefully and surrender possession of the Leased Premises in as good condition as when it was delivered to Lessee, reasonable wear and tear and casualty loss excepted. Lessee shall remove its equipment, personal property, Antenna Facilities, and leasehold improvements from the Property, and shall repair any damage to the Property caused by such equipment, all at Lessee's own cost and expense.
- (b) In the event that Lessee's Antenna Facilities and related equipment are not removed and the Property is not restored to the reasonable satisfaction of the Lessor within sixty (60) days from the termination or expiration date, the Lessor shall have the option to fully decommission the Antenna Facilities, have the Antenna Facilities removed, and repair the site and restore the property, and Lessee shall be responsible for the cost of such actions.

24. Marking and Lighting Requirements.

- (a) Lessor acknowledges that it shall be responsible, at its sole cost and expense, for compliance with all building marking and lighting requirements that the Federal Aviation Administration ("FAA") may require with respect solely to the height of the Structure. The responsibility, however, is expressly limited to the requirements that would be required of an elevated water storage facility having no communications equipment installed on it, irrespective of Lessee's Antenna Facilities. Lessor shall indemnify and hold harmless Lessee from any fines or other liabilities caused by Lessor's failure to comply with such requirements for an elevated water storage facility Structure. Further, should the FAA cite Lessor, or in the event any claims are brought against Lessor because the Structure alone is not in compliance, as opposed to the Structure with Antenna Facilities, then Lessor shall indemnify Lessee for full costs, liabilities, damages and expenses, including reasonable attorney's fees. Further, if Lessor does not cure the conditions of noncompliance on the Structure within the time frame allowed by the citing agency, Lessee may terminate this Lease immediately without any further liability hereunder upon written notice to Lessor.
- (b) Lessee acknowledges that it shall be responsible at its sole cost and expense, for compliance with all building marking and lighting requirements that the FAA may require with respect to Lessee's Antenna Facilities. In the event the FAA determines that

the Structure must be additionally marked, lighted, or in any way modified, due to the existence of Lessee's Antenna Facilities, Lessee shall have the option to mark, light or modify the Structure at its sole expense, or to terminate this Lease, pursuant to *Section 14. Termination*. Said marking, lighting and modifying shall be subject to prior written approval by Lessor, such approval not to be withheld without cause. Lessor shall approve or object to such plans within a reasonable period of time to allow timely compliance with FAA regulations.

25. RF Radiation Compliance.

- (a) An RF Engineer approved by the Lessor shall perform a radiation survey of the Property following Lessee's initial RF transmissions on the Leased Premises. Lessee shall be responsible for all costs of such survey.
- (b) Lessee shall implement all measures at the transmission site required by FCC regulations, including but not limited to posting signs and markings. Lessor shall cooperate with and permit Lessee to implement all reasonable measures in order for Lessee to fulfill its Radio Frequency exposure obligations. Lessor agrees that in the event any future party causes the entire site to exceed FCC Radio Frequency radiation limits, as measured on the Premises, Lessor shall hold such future party liable for all such later-arising non-compliance.

26. Third Party Approvals, Inspections and Evaluations.

The Lessee shall be responsible for all reasonable costs, as determined by Lessor, associated with obtaining required reviews, approvals, inspections, studies, surveys or evaluations, whether required by this Lease or by other governing authorities.

27. Noise Restrictions.

- (a) All wireless service facilities shall be constructed and operated in such a manner as to minimize the amount of noise impacts to residents of nearby homes and the users of recreational areas, such as public parks and trails. Proposed anticipated noise levels must be approved by Lessor. Plan review may require noise reduction measures.
- (b) Noise from Lessee's equipment shall not exceed the level allowed by the local jurisdiction ("Allowable Noise Level"), as measured at any location on neighboring property. Lessor will take noise level measurements from time to time to verify compliance. In the event it is found that Lessee's equipment exceeds the Allowable Noise Level, Lessor shall provide Lessee with written notice and Lessee shall take immediate steps to provide permanent reduction in the noise of its equipment to the Allowable Noise Level. If Lessee does not so reduce its Measured Sound Level within sixty (60) days of receipt of written notice of event, said occurrence shall constitute an event of default as otherwise defined in *Section 14. Termination*.
- (c) Board reserves the right to require noise reduction measures necessary to reduce noise to a level determined solely by the Board.

28. Miscellaneous.

- (a) Each party agrees to furnish to the other, within thirty (30) days after notice of receipt of the request, such truthful estoppel information as the other party may reasonably request.
- (b) This Lease constitutes the entire agreement and understanding of the parties and supersedes any and all offers, negotiations, or other agreements of any kind with respect to its subject matter. There are no representations or understandings of any kind not set forth herein. Any modification of or amendment to this Lease must be in writing and executed by both parties. No provision of this Lease will be deemed waived by either party unless expressly waived in writing by the waiving party. No waiver shall be implied by delay or any other act or omission of either party. No waiver by either party of any provisions of this Lease shall be deemed a waiver of such provision with respect to any subsequent matter relating to such provision.
- (c) This Lease shall be construed in accordance with the laws of the State of Minnesota. Any legal action may only be commenced and proceed in the relevant district court in Ramsey County, Saint Paul, Minnesota.
- (d) If any term of this Lease is found to be void or invalid, such invalidity shall not affect the remaining terms of this Lease, which shall continue in full force and effect.
- (e) Upon request by Lessee, Lessor agrees to execute a recordable Memorandum of this Lease.
- (f) Any terms and conditions contained in this Lease that by their sense and context are intended to survive the termination or expiration of this Lease shall so survive.
- (g) The submission of this Lease to any party for examination or consideration does not constitute an offer, reservation of or option for the Leased Premises based on the terms set forth herein. This Lease will become effective as a binding Lease only upon the handwritten legal execution and delivery hereof by Lessor and Lessee.
- (h) The parties acknowledge that space at the Leased Premises was previously leased between Lessor and Lessee under the terms and conditions of that certain Water Tower Site Lease Agreement dated September 19, 1996, as supplemented to by that certain Lease Supplement dated September 25, 1996, as modified by that certain Consent Letter dated June 21, 2013, as modified by that certain Consent Letter dated November 1, 2013, and as amended by Amendment No. 1 to Site Lease Agreement dated January 26, 2017 (collectively, the "Prior Lease"). Lessor and Lessee acknowledge and agree that the Prior Lease expires effective as of 11:59 p.m. on March 31, 2017, and that thereafter, the terms and conditions of this Lease shall be the sole instrument governing the leasing of space by Lessee at the Property.

- (i) Exhibits “A” through “F” listed below and attached hereto are hereby incorporated into this Lease by reference.

Exhibit “A” *Legal Description*

Exhibit “B” *Site Survey*

Exhibit “C” *Construction Plans*

Exhibit “D” *Antenna Facilities and Frequencies*

Exhibit “E” *Security Plan*

Exhibit “F” *Memorandum of Lease Recording*

[Remainder of this page is left intentionally blank]

IN WITNESS WHEREOF, the parties hereto have executed this Lease, the day and year first written below.

For Lessor:

Approved:

By _____
Stephen P. Schneider, General Manager
Saint Paul Regional Water Services

Approved as to form:

By _____
Assistant City Attorney

**BOARD OF WATER COMMISSIONERS
OF THE CITY OF SAINT PAUL**
FIN # 41-6005521

By _____
Matt Anfang, President

By _____
Mollie Gagnelius, Secretary

CITY OF SAINT PAUL

By _____
Kristin Beckmann, Deputy Mayor

By _____
Shari Moore, City Clerk

By _____
Todd Hurley, Director
Office of Financial Service

For Lessee:

SPRINT SPECTRUM L.P.

By: _____

Print name: _____

Title: _____

Date: _____

EXHIBIT "A"

Legal Description

That part of the Southeast Quarter (SE $\frac{1}{4}$), Section twenty-three (23), Township twenty-nine (29), Range twenty-two (22), commencing at a point 678.71 feet East of the Northwest corner of Lot 12, Katherine's Addition, according to the recorded plats thereof on file and of record in the Office of the Registrar of Titles, in and for Ramsey County, Minnesota; thence South 268.97 feet to a point 711.69 feet Easterly from the West line of the Northwest Quarter (NW $\frac{1}{4}$) of the Southeast Quarter (SE $\frac{1}{4}$) of Section twenty-three (23), Township twenty-nine (29), Range twenty-two (22) Ramsey County, Minnesota; thence Easterly 162 feet; thence Northerly to the South line of Cottage Avenue. All in Ramsey County, Minnesota

EXHIBIT “B”

**Initial Site Survey
Dated 07/30/1996**

**Fiber Survey
Dated 06/17/2013**

Sprint Spectrum

Site Name: ST. PAUL WATER TOWER
Site Number: MS03XC472V1



EAST COTTAGE AVENUE

NORTH 2ND STREET

WATER TOWER

HILLCREST

TERRACE

WATER TOWER

LEGAL DESCRIPTION OF PROPERTY SURVEYED
(Pre-Commonwealth Land Title Insurance Company Community, Case No. 172007, effective date May 24, 1996)

This part of the Southwest Quarter of Section 23, Township 78, Range 12, Ramsey County, Minnesota, is described as follows: Beginning at the northeast corner of the said section; thence west along the southern boundary line of the said section 23, a distance of 100 feet to a point on the south side of the 100-foot wide strip of land running north and south through the center of the said section; thence west along the south side of the 100-foot wide strip of land running north and south through the center of the said section 23, a distance of 100 feet to a point on the south side of the 100-foot wide strip of land running north and south through the center of the said section 23; thence north along the south side of the 100-foot wide strip of land running north and south through the center of the said section 23, a distance of 100 feet to a point on the south side of the 100-foot wide strip of land running north and south through the center of the said section 23; thence east along the south side of the 100-foot wide strip of land running north and south through the center of the said section 23, a distance of 100 feet to the point of beginning.

PROPOSED USE PREMISES LEGAL DESCRIPTION

This part of the Southwest Quarter of Section 23, Township 78, Range 12, Ramsey County, Minnesota, is described as follows: Beginning at the northeast corner of the said section 23; thence west along the southern boundary line of the said section 23, a distance of 100 feet to a point on the south side of the 100-foot wide strip of land running north and south through the center of the said section 23; thence west along the south side of the 100-foot wide strip of land running north and south through the center of the said section 23, a distance of 100 feet to a point on the south side of the 100-foot wide strip of land running north and south through the center of the said section 23; thence north along the south side of the 100-foot wide strip of land running north and south through the center of the said section 23, a distance of 100 feet to a point on the south side of the 100-foot wide strip of land running north and south through the center of the said section 23; thence east along the south side of the 100-foot wide strip of land running north and south through the center of the said section 23, a distance of 100 feet to the point of beginning.

- NOTES:
- 1.) The surveyor is not aware of any encumbrances or other matters of record or not of record affecting the above described property other than as shown.
 - 2.) Locations and size of all underground utilities shown above are based on information from available data provided by various sources.
 - 3.) The survey does not propose to show all underground utilities.
 - 4.) Contact QPQD STATE ONE C.R.L. at 454-0012 for problems on site location of utilities prior to any excavation.
 - 5.) Zoning: R3 (Residential - Single Family)
 - 6.) Subdivision: None, property = 25 feet, frontage = 6 feet, Right-of-way = 2 feet.
 - 7.) Area: 0.531 Sq. Ft. or 0.001 Acre
 - 8.) Area of record: 0.531 Sq. Ft. or 0.001 Acres
 - 9.) The property is located in Plaintiff's Lot 3, which includes the 100' x 100' - plus 5' Right-of-Way. Plaintiff's Lot 3, which includes the 100' x 100' - plus 5' Right-of-Way, is located in Plaintiff's Lot 3, which includes the 100' x 100' - plus 5' Right-of-Way. Plaintiff's Lot 3, which includes the 100' x 100' - plus 5' Right-of-Way, is located in Plaintiff's Lot 3, which includes the 100' x 100' - plus 5' Right-of-Way. Plaintiff's Lot 3, which includes the 100' x 100' - plus 5' Right-of-Way, is located in Plaintiff's Lot 3, which includes the 100' x 100' - plus 5' Right-of-Way.

PROPOSED ADDRESS AND EXPRESS EASION

A 100-foot wide strip of land running north and south through the center of the said section 23, Township 78, Range 12, Ramsey County, Minnesota, is described as follows: Beginning at the northeast corner of the said section 23; thence west along the southern boundary line of the said section 23, a distance of 100 feet to a point on the south side of the 100-foot wide strip of land running north and south through the center of the said section 23; thence west along the south side of the 100-foot wide strip of land running north and south through the center of the said section 23, a distance of 100 feet to a point on the south side of the 100-foot wide strip of land running north and south through the center of the said section 23; thence north along the south side of the 100-foot wide strip of land running north and south through the center of the said section 23, a distance of 100 feet to a point on the south side of the 100-foot wide strip of land running north and south through the center of the said section 23; thence east along the south side of the 100-foot wide strip of land running north and south through the center of the said section 23, a distance of 100 feet to the point of beginning.

DEEDORS NAME & NUMBER

Date: October 10, 1996
Lithograph: #49545650 North
Longitude: #9700-43-07' West

DEEDEE COORDINATES

X = 260291.2617

Y = 103327.5917



Z =

SP 9g 2996

RECORDERS NAME & NUMBER
1.) Top of Buried Control Station, BG and located in Sectional drain - entrance #1 (016-27) feet
2.) Top of Buried Control Station, BG and located in Sectional drain - entrance #1 (016-27) feet
Date: June 30th 1996

SANDO LAND SURVEYING INC.
By: Edward N. Sando, R.L.S., Reg. No. 8812
Survey completed dated May 20th, 1996
REVISED: August 21, 1996 (more precise location)
Site Name: ST. PAUL WATER TOWER
Site Number: MS03XC472V1

Sunde Land Surveying Inc.
500 L. Boulevard #1400 (5th fl.)
(619) 261-2425

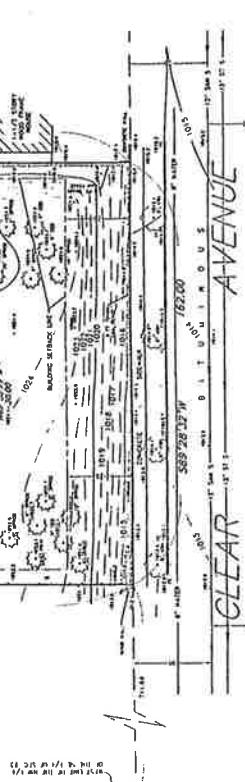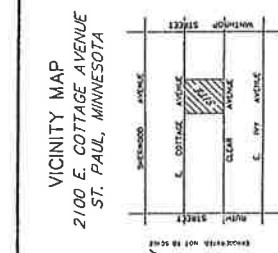



Sprint
ONE SPOT AWAY
ONE PLACE

ONE SPOT AWAY
ONE PLACE



BLACK & VEATCH



Edge
Consulting Engineers Inc.
601 Nicollet Ave., Ste. 1500
Minneapolis, MN 55402
Phone: 612.333.3600
Fax: 612.333.3609
www.edgeconsulting.com

PROJECT NO:	MSD04C472
EDGE PROJECT NO.:	6733
DRAWN BY:	TCD, GGD
CHECHED BY:	CGD

John [Signature]

MSD04C472
TEA FORM OF LAW FOR ANY PERSON
WHO IS NECESSARILY LOCATED IN THE
STATE OF MINNESOTA TO SIGN THIS DOCUMENT
DRAFTED BY [Signature]
ENGINEER TO ALTER THIS DOCUMENT

ST. PAUL WATER TOWER
2100 E COTTAGE AVE
ST. PAUL, MN 55119

Sheet Title
Overall Fiber Plan
SHEET NUMBER
F-1



NOTE:
PROPERTY LINE & BORROW ARE APPROPRIATE AND DONE WITHOUT THE BENEFIT OF A SITE
SURVEY.
2. CONDUIT ROUTING IS DIAGRAMMATICALLY SHOWN ON PLANS AND ARE ONLY APPROXIMATING THE EXACT COORDINATES SHOWN ON FIELD VERIFIED CONDUIT TO FIELD COORDINATES.
3. UNIT ANALYSIS, LAMBERT BROWN ARE APPROXIMATE LOCATION CONTRACTOR.
4. HIGH TYPICAL, WHICH CANNOT BE BORNE IN A DETAIL PLAN.

LENGTH OF FIBER FROM 'A' (ESTIMATE POINT TO NO
DRAFTER) 250' +/-

COTTAGE AVENUE



NORTH

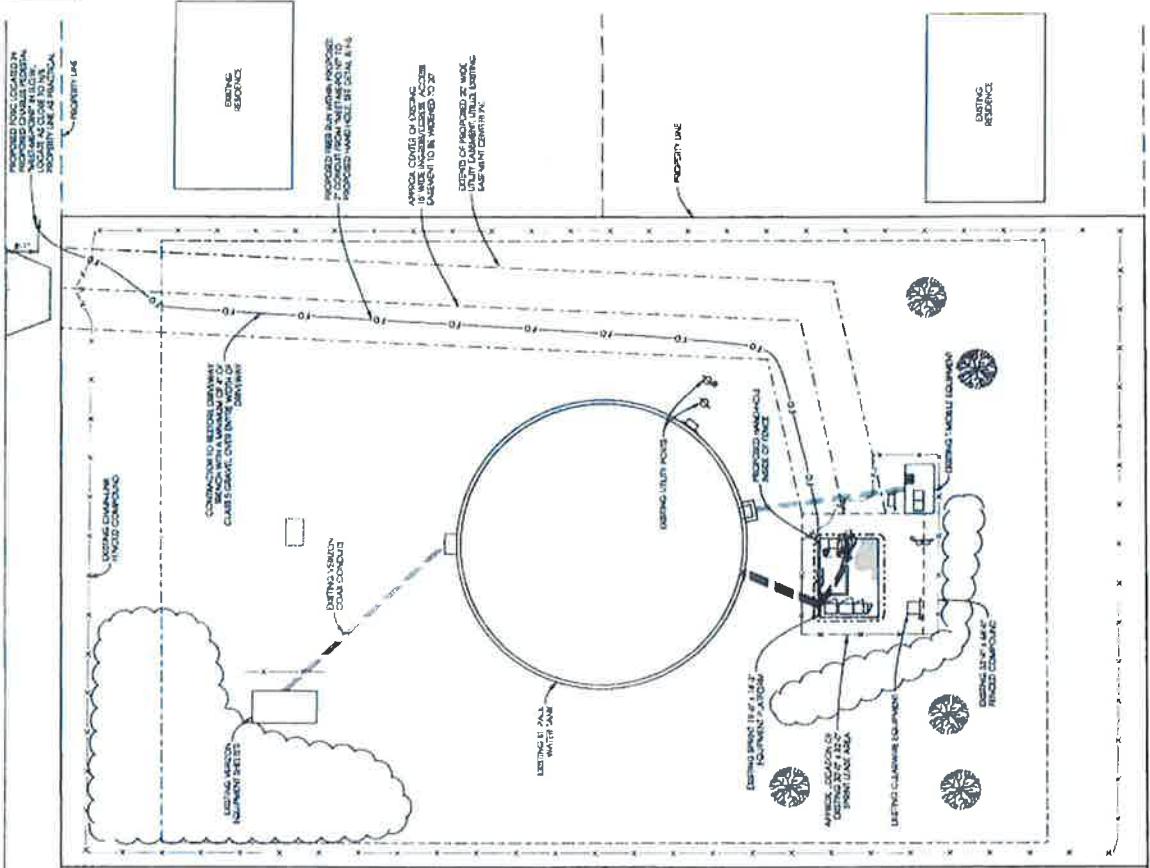


EXHIBIT "C"

**Fiber Construction Plans
Dated 06/17/2013 Rev E**

**Construction Plans
Dated 10/24/2013 Rev 3**



TURBINE FLOW CONTROLLER

TURBINE FLOW CONTROLLER



SAMSUNG



2

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**FOUNDATION, EXCAVATION AND
BACKFILL NOTES**

CONCRETE MASONRY NOTES

ENVIRONMENTAL NOTES

STRUCTURAL STEEL NOTES

- ALL STEEL WORK SHALL BE IN ACCORDANCE WITH THE LATEST EDITION OF THE ASME SECTION OF STEEL. CONCRETE STEEL BARS SHALL BE IN ACCORDANCE WITH ASTM AS205 AS NOTED BELOW.

ANGLE IRON CHANNELS & I-PILES: ANGLES AS205
FLAT SECTION: ANGLES AS205
T-SHAPED SECTION: ANGLES AS205

1. ALL STEEL WORK SHALL BE PAINTED IN A COLOR CONSISTENT WITH THE CONCRETE COLOR.

2. ALL STEEL WORK SHALL BE PAINTED IN A COLOR CONSISTENT WITH THE CONCRETE COLOR.

3. ALL STEEL WORK SHALL BE PAINTED IN A COLOR CONSISTENT WITH THE CONCRETE COLOR.

4. ALL TIED CONNECTIONS SHALL BE ARMORED BEARING THE TIED CONNECTIONS AND SHALL HAVE INTEGRAL PROTECTION FOR THE TIED CONNECTIONS.

5. NO HOMOPATHIC CONNECTIONS FOR STEEL GRATING MAY BE USED. ARRESTA AND RIBBED UNITS ARE NOTED OTHERWISE.


6. RIBBED HOMOPATHIC UNITS ARE TO BE USED IN CONCRETE UNARMED.

הנִזְקָנָה בְּבֵית־יְהוָה וְבַת־יְהוָה בְּבֵית־יְהוָה

- # STRUCTURAL CONCRETE NOTES

CONCRETE MASONRY NOTES

- # STRUCTURAL CONCRETE NOTES

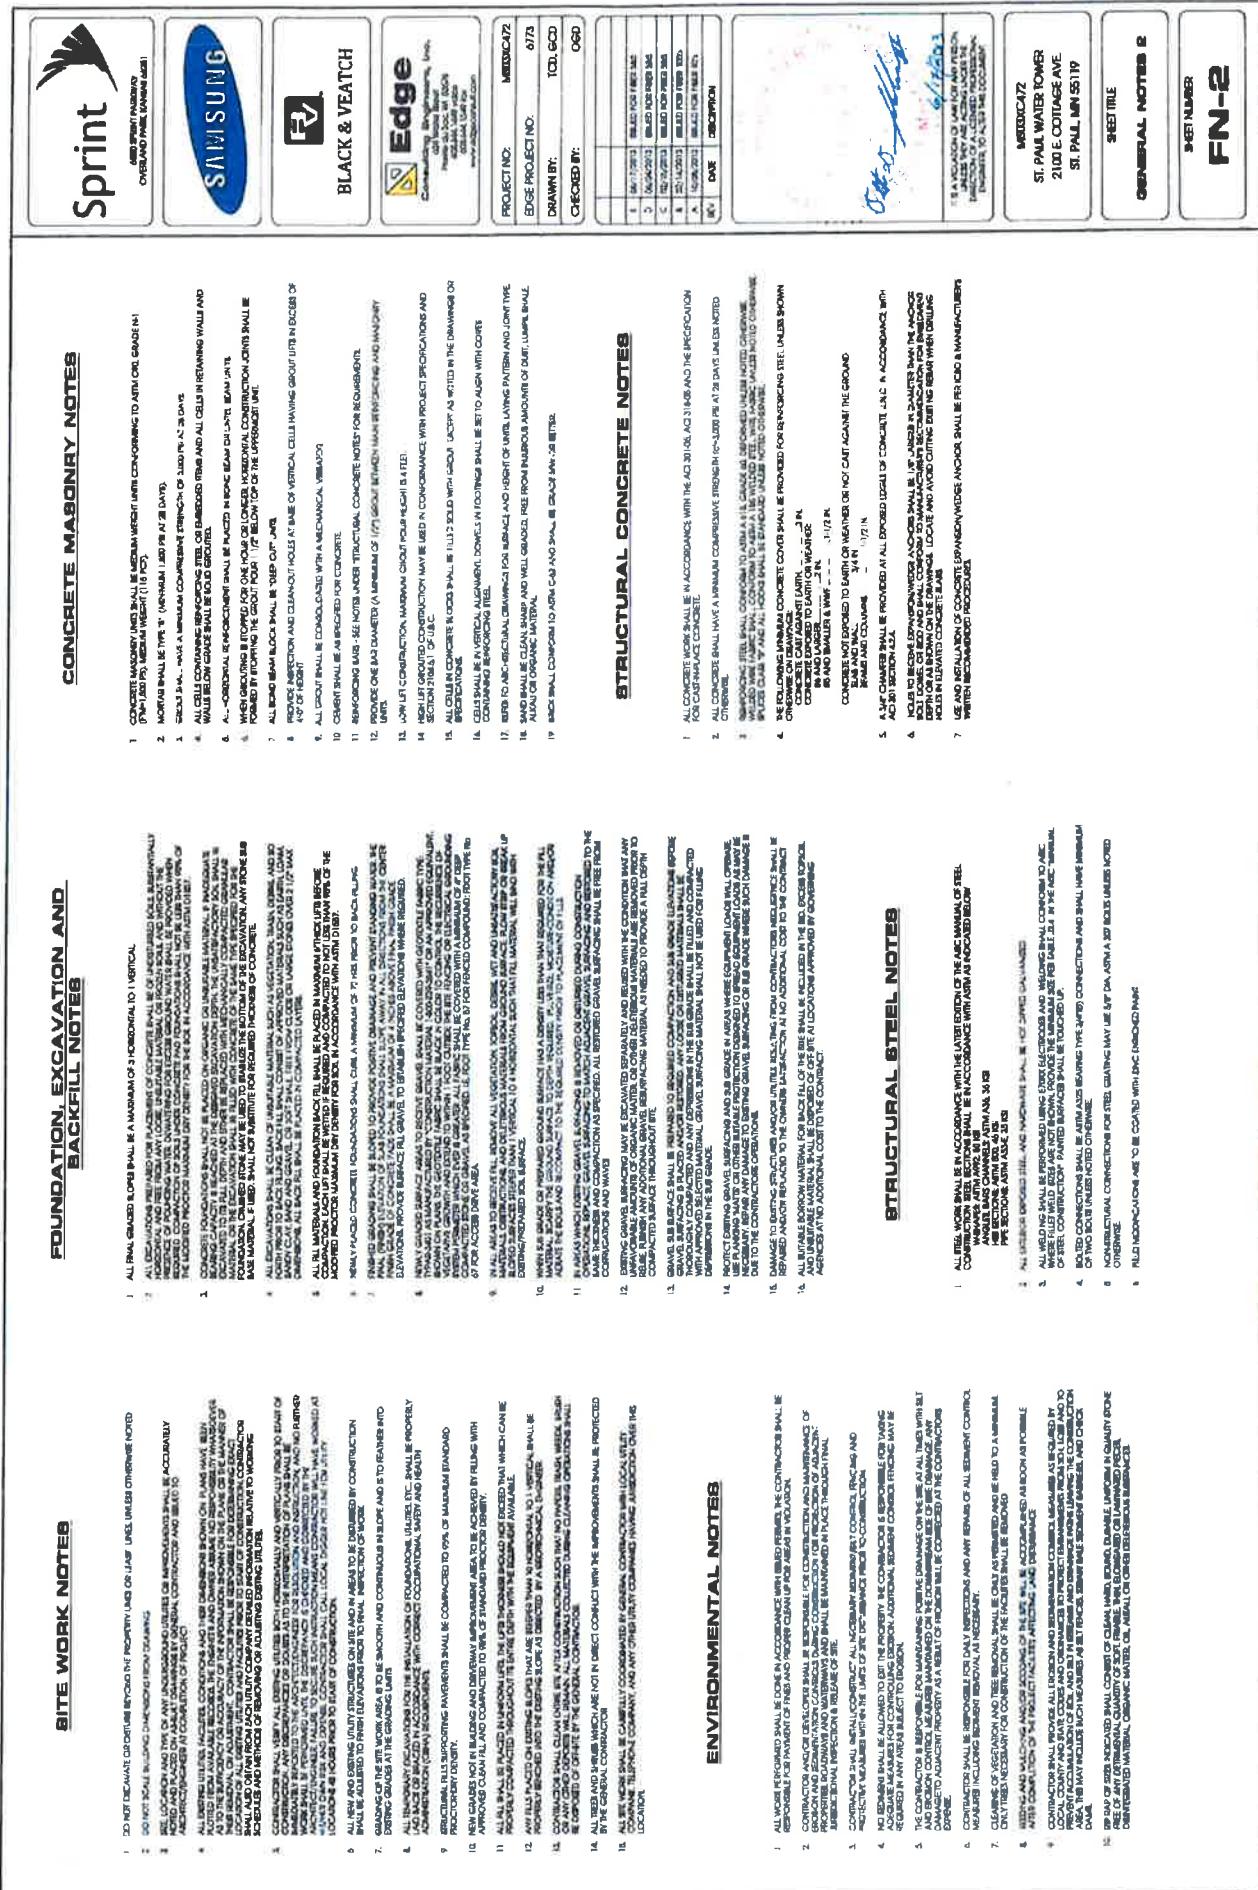



Sprint
4000 NORTH MARSHALL
OVERLAND PARK, KANSAS 66211



SAMSUNG



BLACK & VEATCH



Edge
Consulting Engineers, Inc.
401 North Main Street
P.O. Box 1000
Troy, NY 12180
(518) 437-1000
www.edge.com

NOTES:
1. PROPERTY LINE SHOWN ARE APPROXIMATE AND DONE WITHOUT THE BENEFIT OF A SITE SURVEY.
2. CONCRETE PAVING IS GEOMETRICALLY SHOWN ON PLANS AND ARE ONLY APPROXIMATE. NO BACK DRAZING LOCATIONS FOR PAVING SHALL BE REVERSED.
3. DRAZING LOCATIONS ARE APPROXIMATE. SHOWN AS APPROXIMATE LOCATION CONTRACTOR TO DETERMINE EXACT LOCATION.
4. FOR TYPICAL BENCH DETAIL SEE SHEET 4 - OFFICIAL.

PROJECT NO.: NS03XC472
EDGE PRODUCT NO.: 6773
DRAWN BY: TCD/GCD
CHECKED BY: OGD


Tate, H.A.
TATE, H.A.
C.J. McElroy

NS03XC472
IT IS A VIOLATION OF LAW FOR ANY PERSON, OTHER THAN THE DRAWER OR OWNER OF THIS DOCUMENT, TO MAKE ANY CHANGES OR ALTERATIONS IN THE DRAWINGS, OR TO MAKE ANY COPIES OF THEM, WITHOUT THE WRITTEN APPROVAL OF THE DRAWER OR OWNER.
NS03XC472
ST. PAUL WATER TOWER
2100 E. COTTAGE AVE
ST. PAUL, MN 55119

Sheet Title: **OVERALL FIBER PLATE**
Sheet Number: **F-1**

Scale: **1'-0" = 30'**
1'-0" = 30'

COTTAGE AVENUE

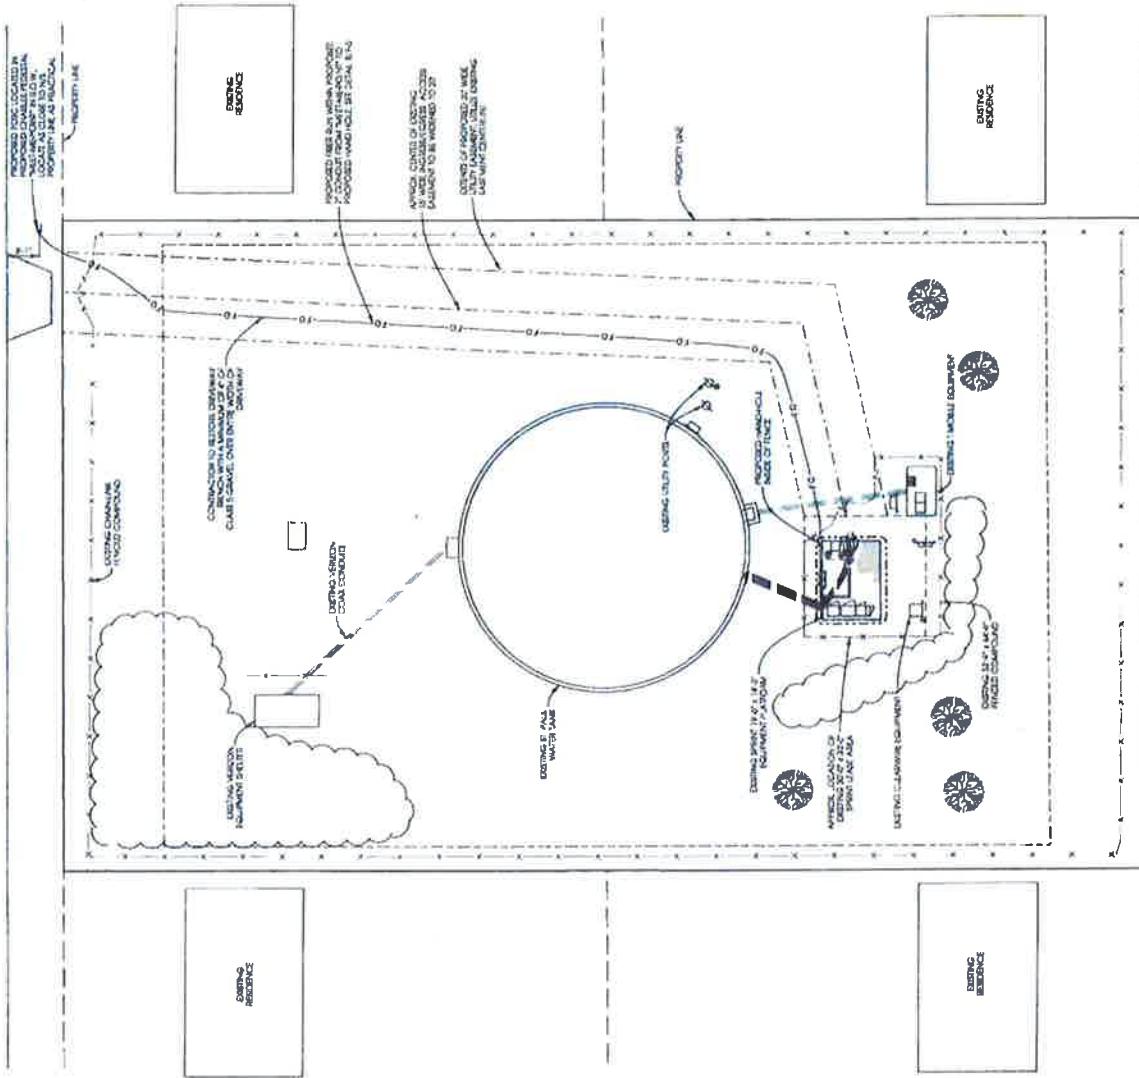

NORTH



Digitized by srujanika@gmail.com

Digitized by srujanika@gmail.com

Digitized by srujanika@gmail.com



SAMSUNG




BLACK & VEATCH



Edge
Software Systems, Inc.

FOR INDOOR AAV (IND) ALTERNATE
POWER SOURCE INSTALLATION

TYPICAL AAV (NUD) POWER SOURCE INSTALLATION

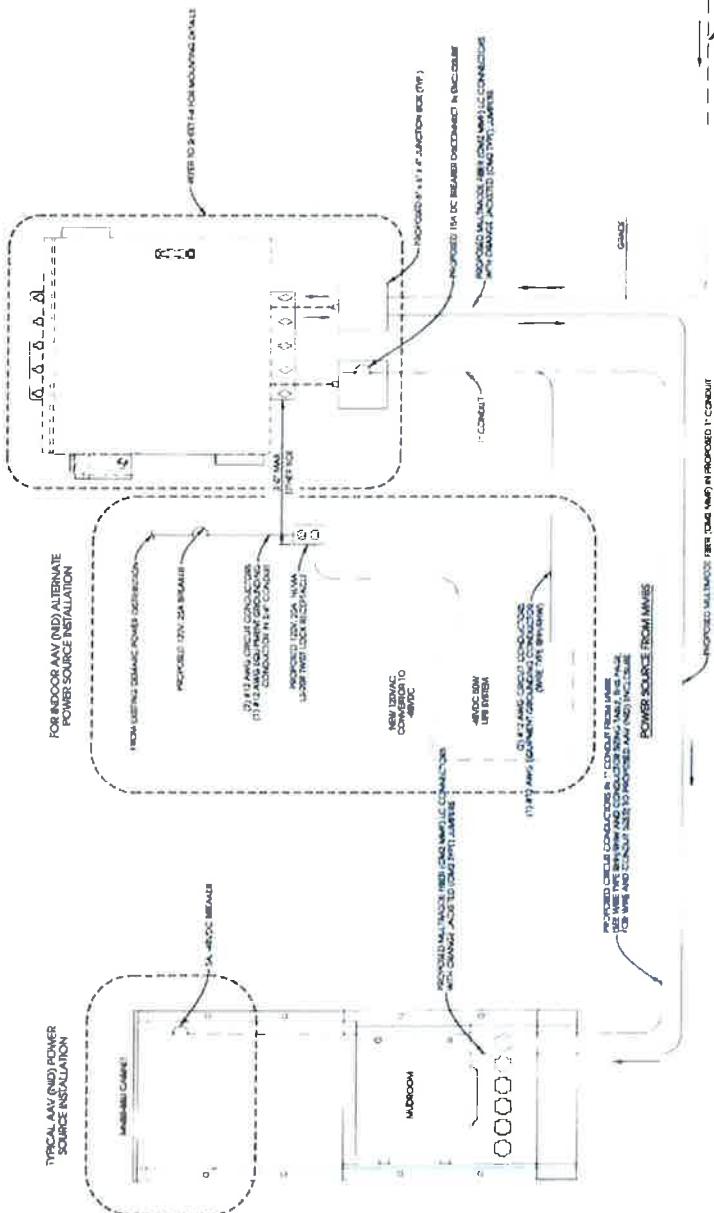

113

SDM/C472

ST. PAUL WATER TOWER
2100 E. COTTAGE AVE.
ST. PAUL, MN 55119

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ENCLOSURE
E-LINE DIAGRAM

STREET NUMBER

WIRE TYPE REVIEW AND CONDUCTOR SIZING TABLE (480VAC @ 90% W/ 2.0 AMPS)					
AMPERAGE (A)	WIRE SIZE	100' LENGTH	200' LENGTH	300' LENGTH	400' LENGTH
100% CIRCUIT BREAKER	12 AWG	(1) 12 AWG	(2) 12 AWG	(3) 12 AWG	(4) 12 AWG
CIRCUIT BREAKER	12 AWG	(1) 12 AWG	(1) 12 AWG	(1) 12 AWG	(1) 12 AWG
CONDUIT SIZE	1-1/2"				

NOTE: CONTRACTOR SHALL FOLLOW ALL LOCAL, MUNICIPAL, COUNTY, STATE AND FEDERAL
LAWS, REGULATIONS, CODES AND ORDINANCES, INCLUDING BUT NOT LIMITED TO:
1. AIR, WATER, SOIL AND GROUND WATER AND GASES;
2. AIR, WATER, SOIL AND GROUND WATER AND GASES;
3. AIR, WATER, SOIL AND GROUND WATER AND GASES;
4. AIR, WATER, SOIL AND GROUND WATER AND GASES.

A **AV (NID) ENCLOSURE ONE-LINE DIAGRAM**

卷二

316



4600 SPRINT HIGHWAY

OVERLAND PARK, KANSAS 66212



BLACK & VEATCH

Engineering
Design Services, Inc.
Planning, Design, Construction
and Project Management
Services for Water
Utilities, Sewerage
Systems, Wastewater
Treatment Plants, Solid
Waste Facilities, and
Industrial Projects

PROJECT NO:

M610KC472

EDGE PROJECT NO:

5773


DRAWN BY:

TCD, GCD

CHECKED BY:

OGD

NOTE
 1. CONTRACTOR SHALL USE UL VERTICALLY STRENGTHENED STEEL
 CONDUITS FOR ALL UTILITIES. THE CONTRACTOR SHALL
 PROVIDE THE CONTRACTOR WITH A COPY OF THE
 CONTRACTOR'S DESIGN AND SPECIFICATIONS FOR
 THE UTILITIES. THE CONTRACTOR SHALL BE
 RESPONSIBLE FOR THE ATTACHMENT OF THE
 UTILITIES TO THE ATTACHMENT POINTS AT THE
 CONTRACTOR'S DISCRETION.

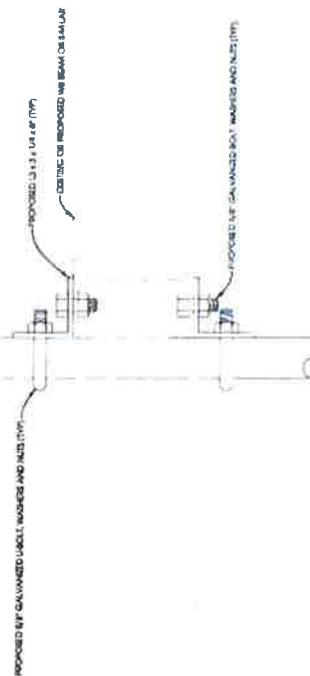NOTICE: All utility conduits shall be placed in the same trench as
 long as a minimum separation per the local utility
 companies is maintained.2. CONTRACTOR SHALL SECURE THE UTILITY TRENCH WITH A
 MINIMUM OF 2' OF CLASS 5 GRAVEL OVER THE ENTIRE WIDTH OF
 THE TRENCH.

H-FRAME MOUNT CONNECTION DETAIL AT I-BEAM
- SIDE VIEW (AS REQUIRED) -

A


F6

SCALE: NS

CONDUIT SPACING SCHEDULE	
CONDUIT #1	
MINIMUM CONDUIT SEPARATION	CONDUIT #2
POWER	POWER
1 - 6 INCHES	1 - 12 INCHES
POWER	TELECOM
1 - 12 INCHES	1 - 6 INCHES
TELECOM	TELECOM
COMMUNICATIONS & CONTROL	COMMUNICATIONS & CONTROL

NOTE	
1	MULTIPLE CONDUITS CAN BE PLACED IN THE SAME TRENCH AS LONG AS A MINIMUM SEPARATION PER THE LOCAL UTILITY COMPANIES IS MAINTAINED
2	CONTRACTOR SHALL SECURE THE UTILITY TRENCH WITH A MINIMUM OF 2' OF CLASS 5 GRAVEL OVER THE ENTIRE WIDTH OF THE TRENCH.

ONE CALL
 BENTON COUNTY
 CALL TO REPORT
 DIGGERS

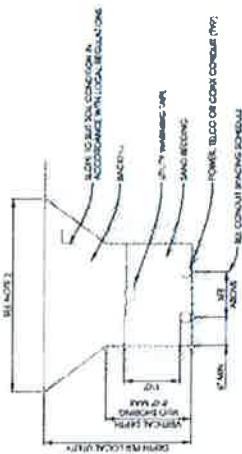

B TYPICAL UTILITY TRENCH DETAIL
SCALE: NS

B
F5

[Signature]
 6/16/2013
 M610KC472
 ST. PAUL WATER TOWER
 2100 E COTTAGE AVE
 ST. PAUL, MN 55110

M610KC472

ST. PAUL WATER TOWER
 2100 E COTTAGE AVE
 ST. PAUL, MN 55110

SHEET TITLE
STANDARD DETAILS

SHEET NUMBER
F-5



Know what's below.
Call before you dig.

Sprint®

ST. PAUL WATER TOWER

MS03XC472

2100 E. COTTAGE AVE.
ST. PAUL, MN 55119

LATITUDE: 44° 9.9824" / 44° 58' 56.96" (NAD 83)
LONGITUDE: -93.0120" / -93° 00' 43.40" (NAD 83)

WATER TOWER

NETWORK VISION MMBSS LAUNCH



ALL WORK AND MATERIALS SHALL BE PERFORMED AND INSTALLED IN ACCORDANCE WITH THE CURRENT EDITIONS OF THE APPROPRIATE CODES AS ADOPTED BY THE LOCAL GOVERNING BODY APPLICABLE TO THESE CODES.
BUILDING CODE: CHAPTER 1204, INC. 2006 BUILDING CODE WITH STATE AMENDMENTS, 2007 INTERIM CODE, 2006
BUDGING CODE: CHAPTER 205, INC. 2006
MECHANICAL CODE: CHAPTER 206, INC. 2006
ELECTRICAL CODE: CHAPTER 211, NATIONAL ELECTRICAL CODE
ACCESSIBILITY CODE: CHAPTER 211, ACCESSIBILITY CODE WITH STATE ADDENDUMS NEW
ENERGY CODE: CHAPTER 211, ENERGY CODE, CHAPTER 211, 1999 MINNESOTA COMMERCIAL ENERGY CODE, CHAPTER 211, 1999

CODE BLOCK

ACCESSIBILITY REQUIREMENTS:
FACILITY IS UNINHABITED AND NOT FOR HUMAN HABITATION. HANDICAPPED ACCESS REQUIREMENTS ARE NOT REQUIRED IN ACCORDANCE WITH THE 2000 IBC BUILDING CODE.
REMOVED EQUIPMENT CABINETS
INSTALL (1) NEW WIRE CABINET
INSTALL (1) NEW PERFORATED FIBER OPTIC CABLES USING EXISTING COAX ROUTE 1 (1 FT SECTOR)
RELOCATE (6) NEW PERFORATED FIBER OPTIC CABLES USING EXISTING COAX ROUTE 1 (1 FT SECTOR)
INSTALL (6) NEW ARDUOS (1 FT SECTOR)

PROJECT DESCRIPTION

FROM MINNEAPOLIS-SAINT PAUL INTERNATIONAL AIRPORT:



VICINITY MAP

1. HEAD SOUTHWEST ON GUMBACK DRIVE (0.8 MILES)
2. KEEP LEFT AT THE FORK AND MERGE ONTO MN-5 E (3.9 MILES)
3. TAKE EXIT ONTO I-35 E N (4.6 MILES)
4. TAKE EXIT 10B FOR PENNSYLVANIA AVE.
PHALEN ROAD (3.0 MILES)
5. TURN RIGHT TO MARYLAND AVE. E (0.7 MILES).
TURN LEFT INTO WHAT BEAR AVE. N (0.4 MILES).
TURN RIGHT ONTO COTTAGE STREET (0.6 MILES).

DRIVING DIRECTIONS

PROJECT SUMMARY

T-1 3



Optima
TELECOM
SERVICES

WILLIN

SAMSUNG


SHEET		DESCRIPTION																					
T-1	TITLE SHEET	1961 NORTHPOINT BLVD., SUITE 130 HIXSON, TN 37343 PH: 423-843-9500 FAX: 423-843-9509																					
N-1	GENERAL NOTES	I HEREBY CERTIFY THAT THE PLAN SPECIFICATION, OR REPORT WAS PREPARED BY ME UNDER MY DIRECT SUPERVISION AND THAT I AM A FULLY LICENSED ARCHITECT UNDER THE LAWS OF THE STATE OF MINNESOTA.																					
N-2	GENERAL SITE PLAN	<i>[Signature]</i>																					
A-1	ELEVATION	PRINT NAME: STEPHEN F. WILLIN																					
A-2	ANTENNA PLANS (ALL SECTORS)	DATE: C-2 / Z / 13 LICENSE #47488																					
A-3	INTERNA PLANS (ALL SECTORS)	PROJECT INFORMATION: NETWORK VISION MMBS LAUNCH																					
A-4	EQUIPMENT DETAILS	ST. PAUL WATER TOWER																					
A-5	EQUIPMENT DETAILS (OUTDOOR SPARES/ENTRANCES)	MS03XC472																					
A-6	EQUIPMENT DETAILS	2100 E. COTTAGE AVE. ST. PAUL, MN 55119																					
A-7	CO-OP COLOR COORDINATE	RAMSEY COUNTY																					
E-1	CHIEF CADMAN & POWER POINT SCHEDULE	DRAWN BY: [Signature]																					
E-2	ELECTRICAL DETAILS	CHECKED BY: [Signature]																					
E-3	GROUNDS & ROUTING PLANS	DATE: 08-19-13																					
GR-1	GROUNDS DETAILS	TITLE SHEET																					
GR-2	GROUNDS DETAILS	SHEET NUMBER: T-1																					
SHEET INDEX																							
<table border="1"> <tr> <td>1</td> <td>AREA MAP</td> </tr> <tr> <td>2</td> <td>VICINITY MAP</td> </tr> <tr> <td>3</td> <td>CODE BLOCK</td> </tr> <tr> <td>4</td> <td>PROJECT DESCRIPTION</td> </tr> <tr> <td>5</td> <td>DRIVING DIRECTIONS</td> </tr> <tr> <td>6</td> <td>SIGNATURE BLOCK</td> </tr> </table>				1	AREA MAP	2	VICINITY MAP	3	CODE BLOCK	4	PROJECT DESCRIPTION	5	DRIVING DIRECTIONS	6	SIGNATURE BLOCK								
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6	SIGNATURE BLOCK																						
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10	APPROVAL: SIGNATURE: [Signature] DATE: [Signature]																						

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Optima

WILL LIN



1961 NORTHPOINT BLVD., SUITE 130
HINSON, TN 37343
PH: 423-943-9500 FAX: 423-943-9509

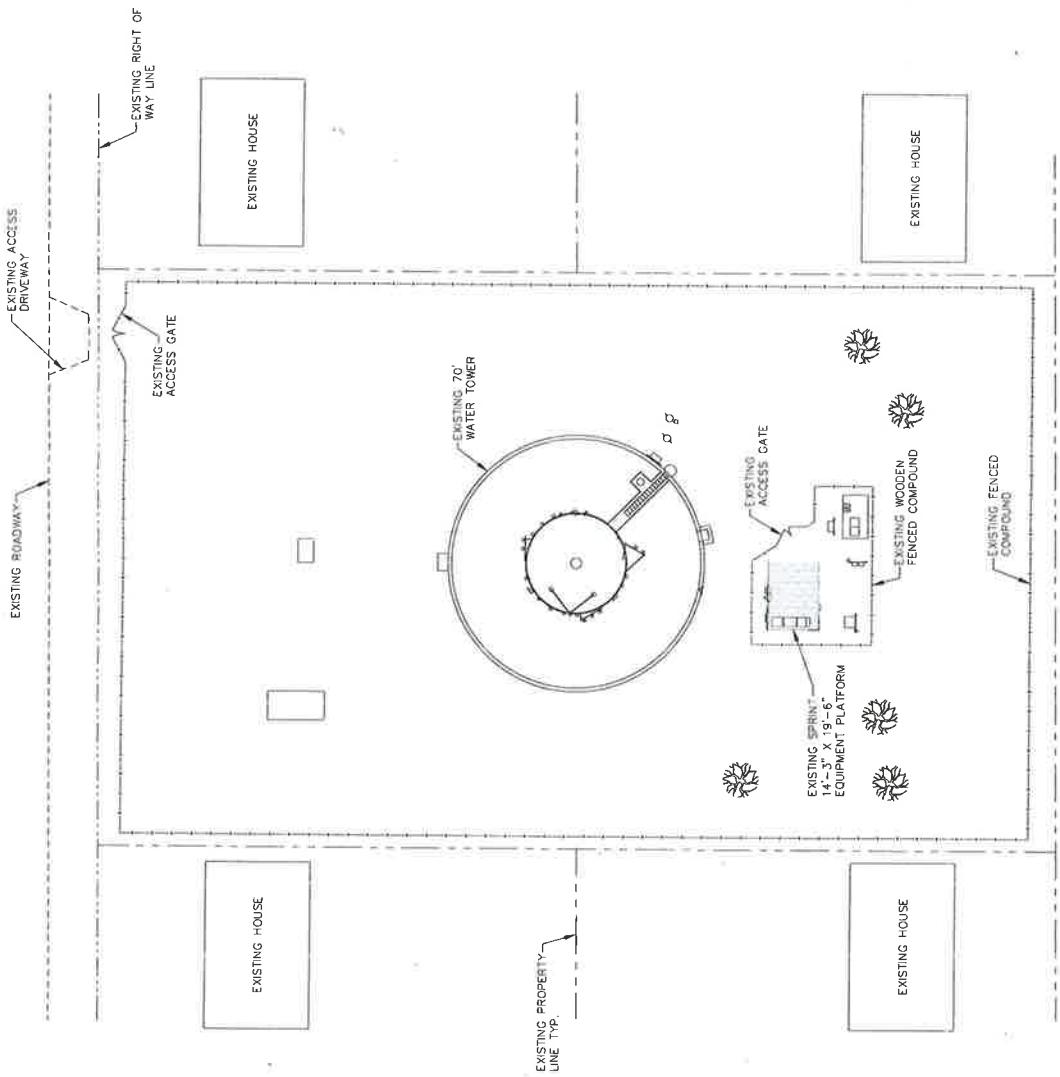I HEREBY CERTIFY THAT THIS PLAN SPECIFICATION OR REPORT WAS PREPARED BY ME OR UNDER MY DIRECT SUPERVISION AND THAT I AM A DULY LICENSED ARCHITECT UNDER THE LAWS OF THE STATE OF MINNESOTA.

JULIE S. ULT

SIGNATURE

PRINT NAME: STEPHEN E. WATKIN

DATE: 01/24/13

LICENSE #47489

PROJECT INFORMATION

NETVORK VISION MANGI LARSON

ST. PAUL WATER TOWER

MS03XC472

2100 E. COTTAGE AVE.
ST. PAUL, MN 55119
RAMSEY COUNTY

DRAWN BY

TDD

SEH

08-19-13

REVIEWED BY

TDD

SEH

08-19-13

REV

Sheet Number

REV

A-1 3

THIS IS NOT A SITE SURVEY.
ALL PROPERTY BOUNDARIES, ORIENTATION OF
TRUE NORTH AND STREET HALF-WIDTHS HAVE
BEEN ESTIMATED BASED OFF OF PROVIDED
INFORMATION AND ONLINE GIS.

1 OVERALL SITE PLAN
1x17 SCALE; NOT TO SCALE | 24x36 SCALE; NOT TO SCALE

11x17 SCALE; NOT TO SCALE | 24x36 SCALE; NOT TO SCALE

Sprint®



Optima
COMMUNICATIONS

WILLIN'

REV	DATE	DESCRIPTION	REVISION	BY
3	10-24-13	ISSUED FOR CONSTRUCTION	JAE	SEH
2	10-24-13	ISSUED FOR CONSTRUCTION	JAE	SEH
1	10-24-13	ISSUED FOR CONSTRUCTION	JAE	SEH
0	08-20-13	ISSUED FOR CONSTRUCTION	TDD	SEH



1961 NORTHPOINT BLVD., SUITE 130
HURON, IN 47343
PH: 423-843-9500 FAX: 423-843-9509

I HEREBY CERTIFY THAT THE PLAN SPECIFICATION OR
REPORT WAS DRAWN BY ME OR UNDER MY DIRECT
SUPERVISION SO THAT IT MAY BE REFERRED
TO AN ARCHITECT UNDERTAKING THE LAWS OF THE STATE OF
MINNESOTA.

Steve Hunt
SIGNATURE

PRINT NAME: STEPHEN HUNT

DATE: 07-24-13 LICENSE #47489

PROJECT INFORMATION

NETWORK VISION WIRELESS
ST. PAUL WATER TOWER

MS03XC472

2100 E COTTAGE AVE.
ST. PAUL, MN 55119
RAMSEY COUNTY

OWNER:

TDD

SEH

DATE:

08-19-13

SHEET NUMBER:

COMPOUND

PLAN


REV

A-2

3

NOTE:
1. ABANDONED PVC TO BE CAPPED BELOW
GRADE AND COVERED WITH CONCRETE. PVC SHALL BE CAPPED PLUS WITH
GRADE AND CAPPED
2. NOisy EQUIPMENT TO BE REMOVED UPON
FINAL MIGRATION

NOTE:
1. ABANDONED PVC TO BE CAPPED BELOW
GRADE AND COVERED WITH CONCRETE. PVC SHALL BE CAPPED PLUS WITH
GRADE AND CAPPED
2. NOisy EQUIPMENT TO BE REMOVED UPON
FINAL MIGRATION

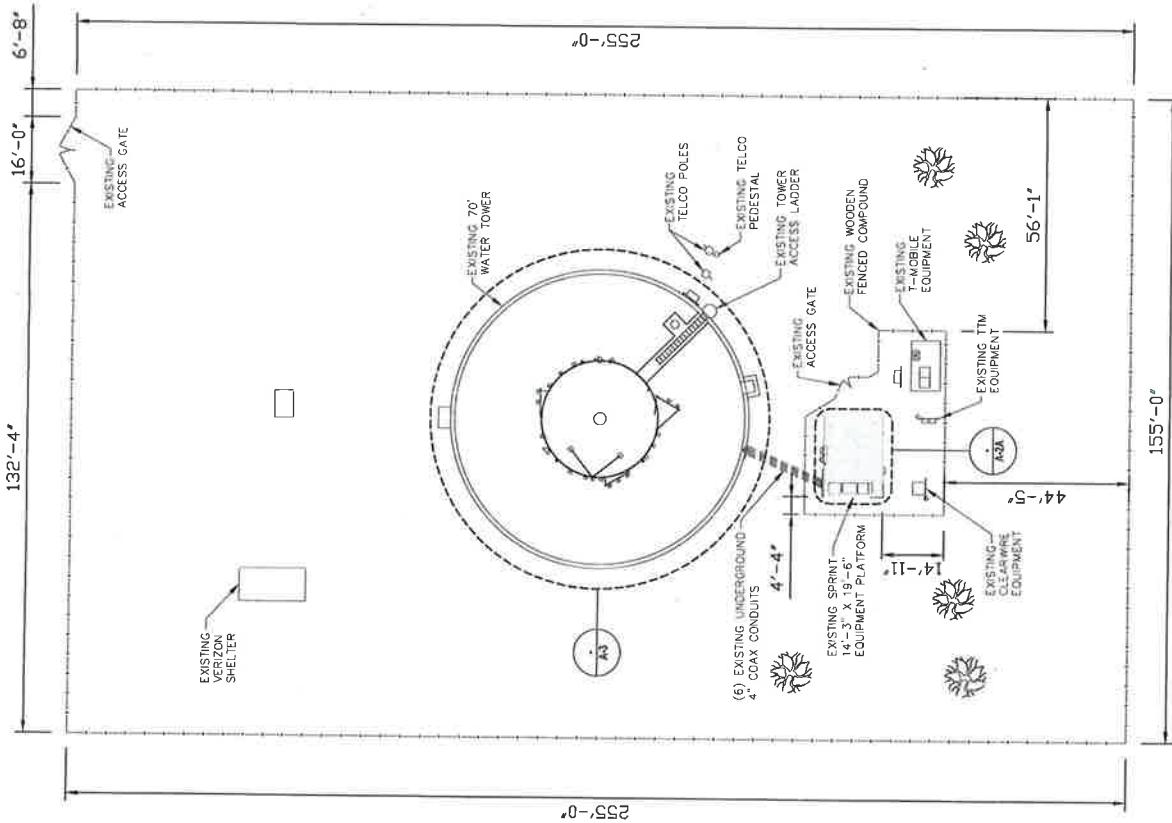

1 COMPOUND PLAN - EXISTING

24x36 SCALE: 1'=5'

11x17 SCALE: 1'=5'

REV

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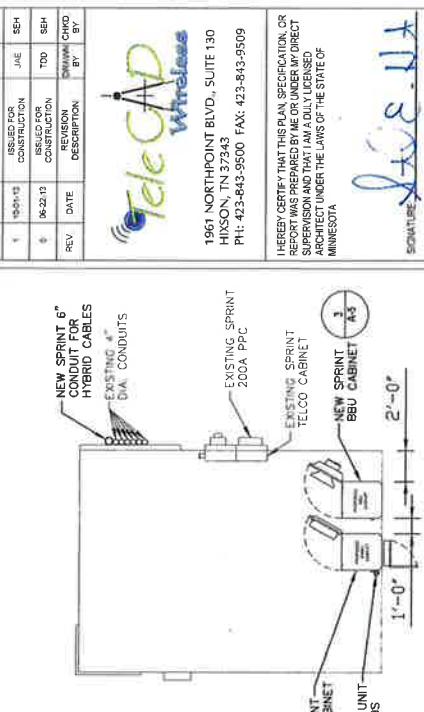
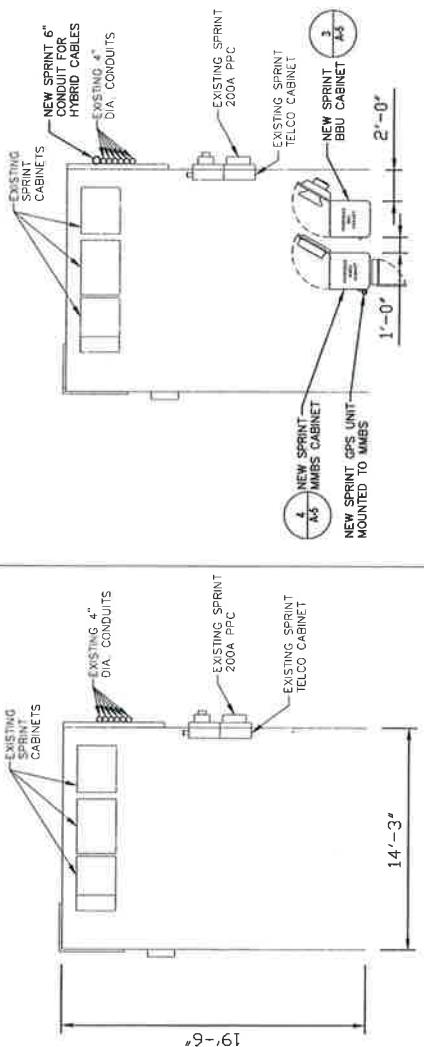
Willin

NOTE:
 1. CONTRACTOR TO REPLACE ALL MISSING GROUND BARS
 AND GROUNDBUS CONNECTIONS AS REQUIRED.
 2. CONTRACTOR TO OBTAIN STRUCTURAL ANALYSIS
 ON PLATFORM BY OTHERS PRIOR TO PLACEMENT
 OF NEW EQUIPMENT CABINETS.

ROUTE CABLES/COAX IN 2"
 FLEX TO MMBS AND RRU IF
 LESS THAN 6' FROM
 EXISTING ICE BRIDGE

THE PROPOSED MMBS-BBU CABINET AND BATTERY CABINET
 NEED TO BE FLUSH MOUNTED TO THE EXISTING SPRINT
 DIRECTLY OVER TWO COM 13 CHANNELS. THE TOP ROLLS
 OF THE 'C' CHANNELS SHOULD BE TACK WELDED TO
 THE GRATING AT APPROXIMATELY FOUR FEET ON CENTER TO
 PREVENT A POSSIBLE BUCKLING MODE OF FAILURE

ROUTE CABLES/COAX IN 2"
 FLEX TO MMBS AND RRU IF
 LESS THAN 6' FROM
 EXISTING ICE BRIDGE



REV.	DATE	ISSUED FOR CONSTRUCTION	ISSUED FOR CONSTRUCTION	ISSUED FOR CONSTRUCTION	ISSUED FOR CONSTRUCTION	REVISION DESCRIPTION
1	10-24-13	SEH	SEH	SEH	SEH	
2	10-14-13	JAE	SEH	JAE	SEH	
3	10-21-13	JAE	SEH	TOD	SEH	
4	06-22-13	TOD	SEH			

SIGNATURE

DATE

PRINT NAME: STEPHEN E. HANF


PROJECT INFORMATION

ST. PAUL WATER TOWER

MS03XC472

2100 E. COTTAGE AVE.
 ST. PAUL, MN 55119
 RAMSEY COUNTY

DRAWN BY TDD CHECKED BY SEH DATE 08-19-13
 SHEET TITLE: NEUTRONIC VENOM MINI LAUNCH
 EQUIPMENT PLANS
 SHEET NUMBER: REV.

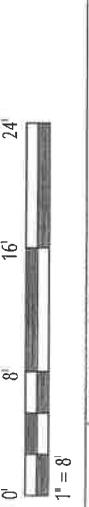

A-2A 3

11x17 SCALE: 1"-8"
 24x36 SCALE: 1"-4"
 11x17 SCALE: 1"-8"
 24x36 SCALE: 1"-4"
 11x17 SCALE: 1"-8"
 24x36 SCALE: 1"-4"

1 2 3 FINAL EQUIPMENT PLAN
 11x17 SCALE: 1"-8"
 24x36 SCALE: 1"-4"

1 2 3 EXISTING EQUIPMENT PLAN
 11x17 SCALE: 1"-8"
 24x36 SCALE: 1"-4"


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800/1900 EQUIPMENT

RRU / HYBRID CABLE SCHEDULE							
SECTOR	RRU MODEL	RRU FREQUENCY	HYBRID CABLE LENGTH	HYBRID CABLE DIAMETER	JAMPER LENGTH	RET. LENGTH	RET. CABLE
ALPHA	RRH-C2A & RRH-P1(B)OMRH2 & (1)1900MHz	190	1/2"	0.98"	6'	9.8'	COMMSCOPE ATG9-B91-0003
BETA	RRH-C2A & RRH-P1(B)OMRH2 & (1)1900MHz	225	1/2"	0.98"	6'	9.8'	COMMSCOPE ATG9-B91-0003
Gamma	RRH-C2A & RRH-P1(B)OMRH2 & (1)1900MHz	165	0.98"	1/2"	6'	9.8'	COMMSCOPE ATG9-B91-0003



NOTE: EXISTING ANTENNAS ARE CDAW UNLESS NOTED OTHERWISE.
NEW SPRINT ANTENNAS INCLUDE RESPECTIVE RMS WHICH SHALL BE MOUNTED ON THE PIPE BEHIND THE ANTENNA SIMILAR TO THAT SHOWN ON DETAIL 1, SHEET A-6.

FIELD VERIFY EXISTING AZIMUTH BEFORE RELOCATING THE ANTENNA, IF REQUIRED. PRIOR APPROVAL FROM SPRINT TO BE GRANTED BEFORE RELOCATION OF ANTENNAS.

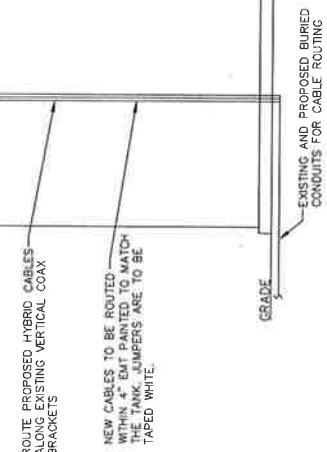ANY ABANDONED CONDUIT TO BE CAPPED ABOVE GRADE.

NOTES:
1. BASE STATION EQUIPMENT NOT SHOWN FOR CLARITY.
2. FINAL ANTENNA CONFIGURATION SHOWN ON THIS PLAN SEE ANTENNA PLAN SHEETS FOR EXISTING AND TEMPORARY INTERIM CONFIGURATION PROVIDED BY OTHERS.
3. EXISTING TOWER INVENTORY PROVIDED BY OTHERS.
4. ALL PROPOSED ANTENNA, RRU AND CABLING WORK SHALL NOT COMMENCE UNTIL A SIGNED AND SEALED STRUCTURAL ENGINEER, SPRINT PLATFORM AND FOUNDATION REPORT IN ACCORDANCE WITH ALL APPLICABLE LOCAL, STATE, AND FEDERAL CODES DRAWINGS THE DESIGN DEPICTED ON THESE DRAWINGS HAS BEEN PROVIDED.

NOTE:
1. BASE STATION EQUIPMENT NOT SHOWN FOR CLARITY.
2. FINAL ANTENNA CONFIGURATION SHOWN ON THIS PLAN SEE ANTENNA PLAN SHEETS FOR EXISTING AND TEMPORARY INTERIM CONFIGURATION PROVIDED BY OTHERS.
3. EXISTING TOWER INVENTORY PROVIDED BY OTHERS.
4. ALL PROPOSED ANTENNA, RRU AND CABLING WORK SHALL NOT COMMENCE UNTIL A SIGNED AND SEALED STRUCTURAL ENGINEER, SPRINT PLATFORM AND FOUNDATION REPORT IN ACCORDANCE WITH ALL APPLICABLE LOCAL, STATE, AND FEDERAL CODES DRAWINGS THE DESIGN DEPICTED ON THESE DRAWINGS HAS BEEN PROVIDED.

(6) EXISTING SPRINT COAX CABLES TO BE REMOVED AFTER EQUIPMENT MIGRATION

EXISTING TOP OF WATER TOWER HANDRAIL


I HEREBY CERTIFY THAT THIS PLAN SPECIFICATION OR REPORT WAS PREPARED BY ME OR UNDER MY DIRECT SUPERVISION AND THAT I AM A FULLY LICENSED ARCHITECT UNDER THE LAWS OF THE STATE OF MINNESOTA

[Signature] JAS. S. JAH
PRINT NAME: JAMES S. JAHN
DATE: 02/22/13
PROJECT NUMBER: 44444444
NETWORX VERION: LAMPSON

ST. PAUL WATER TOWER

1961 NORTHPOINT BLVD, SUITE 130
HIXSON, TN 37343
PH: 423-843-9500 FAX: 423-843-9509

REV	DATE	REVISION	DRAWN BY	CHECKED BY	ELEVATION	SHEET NO./SERIAL
3	10/24/13	ISSUED FOR CONSTRUCTION	JAE	SEH		
2	10/24/13	ISSUED FOR CONSTRUCTION	JAE	SEH		
1	06/22/13	ISSUED FOR CONSTRUCTION	TDD	SEH		

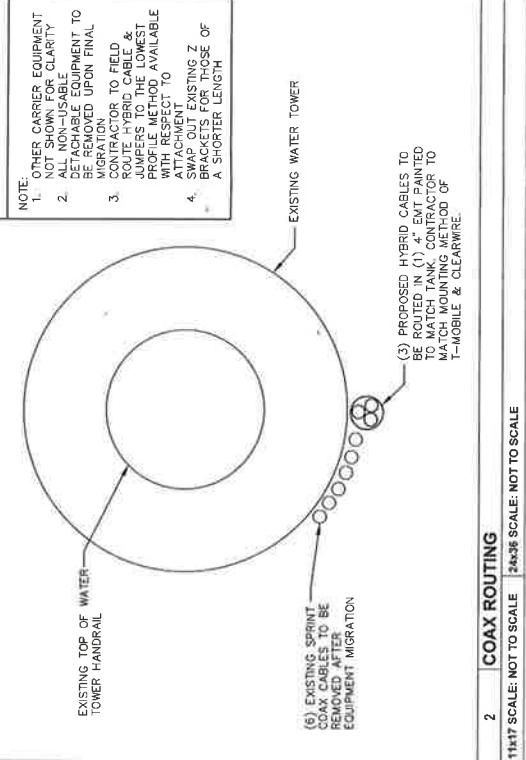

A-3 3

2 COAX ROUTING

11x17 SCALE: NOT TO SCALE 24x36 SCALE: NOT TO SCALE

1 TOWER ELEVATION
11x17 SCALE: NOT TO SCALE 24x36 SCALE: NOT TO SCALE

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WIL LIN



1961 NORTHPOINT BLVD., SUITE 130
HUNSON TN 37343

PH: 423-943-9500 FAX: 423-943-9509

HEREBY CERTIFY THAT THIS PLAN SPECIFICATION OR
REPORT WAS PREPARED BY ME OR UNDER MY DIRECT
SUPERVISION AND THAT I AM A DULY LICENSED
ARCHITECT UNDER THE LAWS OF THE STATE OF
MINNESOTA.

John S. Ulta

SIGNATURE

DATE

PRODUCT INFORMATION

ST. PAUL WATER TOWER

DRAWN BY

TDD

CHREDGED BY

SEH

DATE

08-19-13

SPRINT TOWER


ANTENNA PLAN

(ALL SECTORS)

Sheet Number

REV


A-3A 3

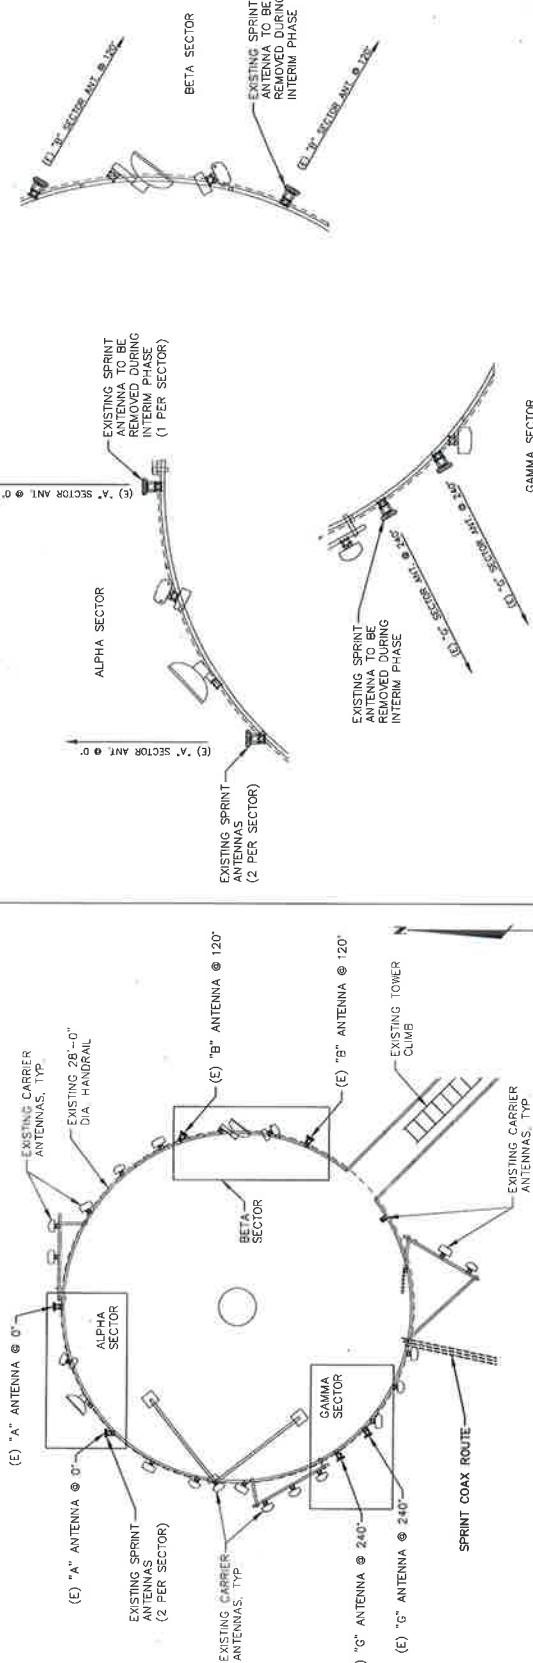

2 ENLARGED ANTENNA PLAN (EXISTING)

11x17 SCALE: NOT TO SCALE | 24x36 SCALE: NOT TO SCALE

EXISTING CARRIER ANTENNAS, TYP
(E) "A" ANTENNA @ 0°
EXISTING SPRINT ANTENNAS (2 PER SECTOR)
(E) "G" ANTENNA @ 240°
EXISTING CARRIER ANTENNAS, TYP
(E) "B" ANTENNA @ 120°
EXISTING TOWER CLIMB
SPRINT COAX ROUTE
ALPHA SECTOR
BETA SECTOR
GAMMA SECTOR
DIA. HANDRAIL
EXISTING 28'-0" DIA. HANDRAIL
EXISTING CARRIER ANTENNAS, TYP
(E) "A" ANTENNA @ 0°
EXISTING SPRINT ANTENNAS (2 PER SECTOR)
(E) "G" ANTENNA @ 240°
EXISTING CARRIER ANTENNAS, TYP
(E) "B" ANTENNA @ 120°
EXISTING TOWER CLIMB
SPRINT COAX ROUTE
ALPHA SECTOR
BETA SECTOR
GAMMA SECTOR
DIA. HANDRAIL
EXISTING 28'-0" DIA. HANDRAIL

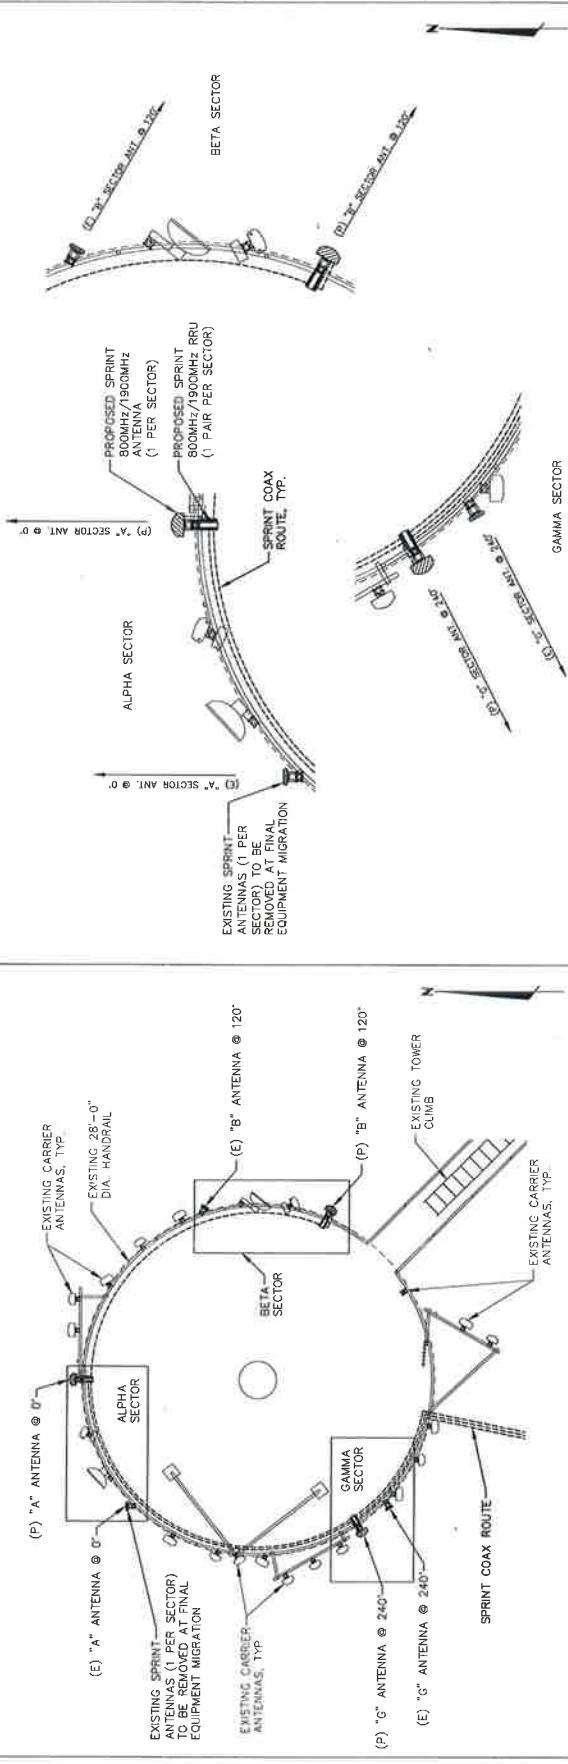


4 ENLARGED ANTENNA PLAN (INTERIM)

11x17 SCALE: NOT TO SCALE | 24x36 SCALE: NOT TO SCALE

EXISTING CARRIER ANTENNAS, TYP
(E) "A" ANTENNA @ 0°
EXISTING SPRINT ANTENNAS (1 PER SECTOR) TO BE REMOVED AT FINAL EQUIPMENT MIGRATION
(E) "G" ANTENNA @ 240°
EXISTING CARRIER ANTENNAS, TYP
(E) "B" ANTENNA @ 120°
EXISTING TOWER CLIMB
SPRINT COAX ROUTE
ALPHA SECTOR
BETA SECTOR
GAMMA SECTOR
DIA. HANDRAIL
EXISTING 28'-0" DIA. HANDRAIL
EXISTING CARRIER ANTENNAS, TYP
(E) "A" ANTENNA @ 0°
EXISTING SPRINT ANTENNAS (1 PER SECTOR) TO BE REMOVED AT FINAL EQUIPMENT MIGRATION
(E) "G" ANTENNA @ 240°
EXISTING CARRIER ANTENNAS, TYP
(E) "B" ANTENNA @ 120°
EXISTING TOWER CLIMB
SPRINT COAX ROUTE
ALPHA SECTOR
BETA SECTOR
GAMMA SECTOR
DIA. HANDRAIL
EXISTING 28'-0" DIA. HANDRAIL

Sprint®

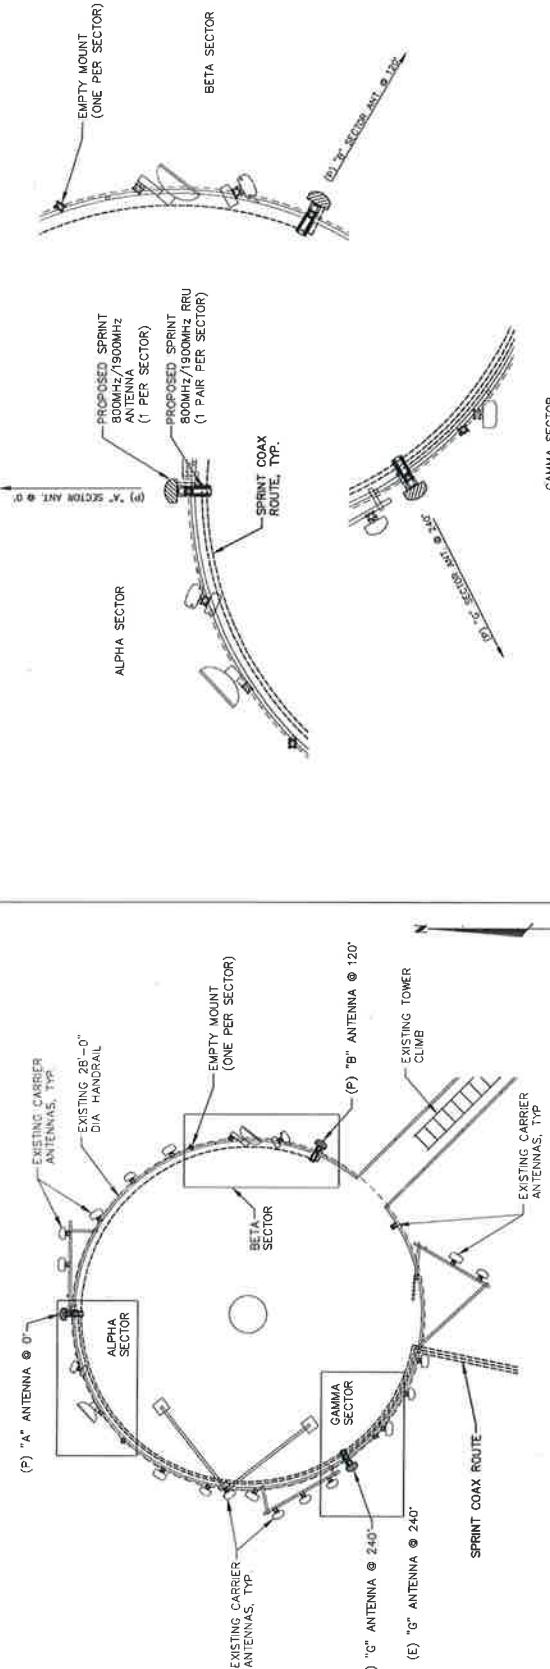

1 ANTENNA PLAN (FINAL)

11x17 SCALE: NOT TO SCALE 24x36 SCALE: NOT TO SCALE

2 ENLARGED ANTENNA PLAN (FINAL)

11x17 SCALE: NOT TO SCALE 24x36 SCALE: NOT TO SCALE

1961 NORTHPOINT BLVD, SUITE 130
HIXON, TN 37343
PH: 423-843-3500 FAX: 423-843-3509

I HEREBY CERTIFY THAT THIS PLAN, SPECIFICATION OR
REPORT WAS PREPARED BY ME OR UNDER MY DIRECT
SUPERVISION AND THAT I AM A DULY LICENSED
ARCHITECT UNDER THE LAWS OF THE STATE OF
MINNESOTA

J. E. H. SEH
SIGNATURE
PRINT NAME: STEPHEN E. HUNT
DATE: 07/24/13 LICENSE #1488

PROJECT INFORMATION
NETWORK VISION INMRS LAUNCH
ST. PAUL WATER TOWER

MSB3XC472


2100 E. COTTAGE AVE
ST. PAUL, MN 55119
RAMSEY COUNTY
DRAWN BY: [REDACTED] SEH DATE: 08-19-13
INSPECTOR: [REDACTED] TDD SEH DATE: 08-19-13
ANTENNA PLAN
(ALL SECTORS)
SHEET NUMBER: [REDACTED]
REV: [REDACTED]

A-3B 3





Optima
BATTERIES

WILL LIN

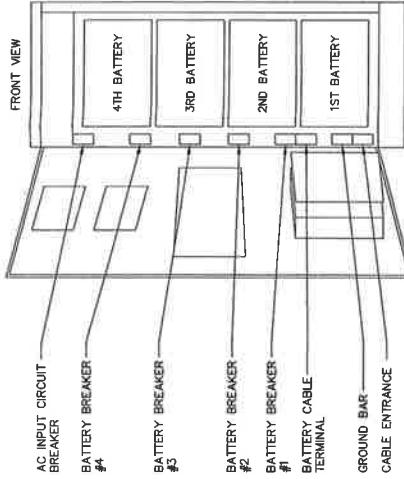


ITEM	SPECIFICATIONS
CAPACITY	MAX 4 BATTERY STRINGS
COOLING	AIR-COOLER/COOLING EMERGENCY AIR COOLING (MCLEAN T20 HYAC)
SOUND LEVEL	65dB @ 1.5m
SIZE	71(H) x 41.25(D) x 27.6(W) INCH 1800(H) x 1048(D) x 700(W) mm
CABINET WEIGHT	370 LBS
PER BATTERY STRING WEIGHT	529 LBS
BATTERY	NARADA 190AH (12V1150) AGM TYPE (VRLA)
AC POWER	220VAC, 3.5AMP TYP 14.4AMP STARTING
DC POWER	10A MAX @48VDC

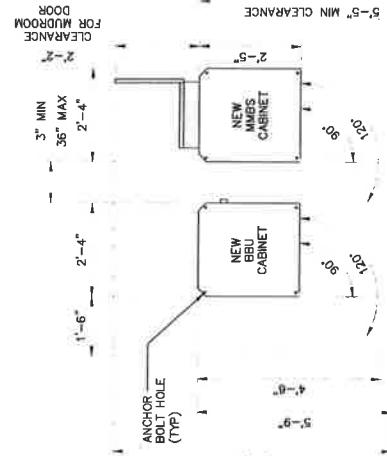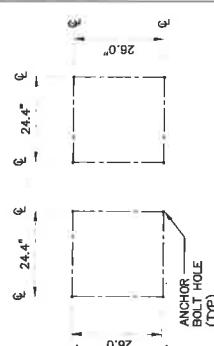


3 **MMBS BBU CABINET**

SCALE: NTS

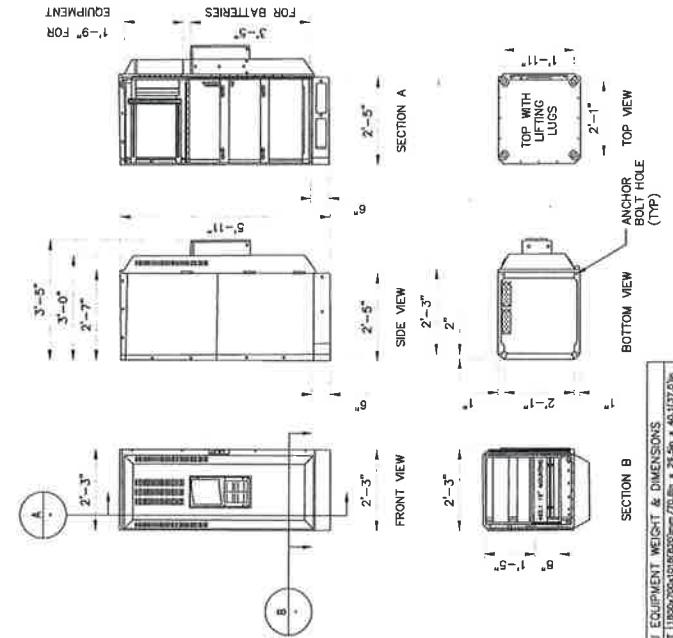

5 **BBU MECHANICAL SPECIFICATIONS**

SCALE: NTS

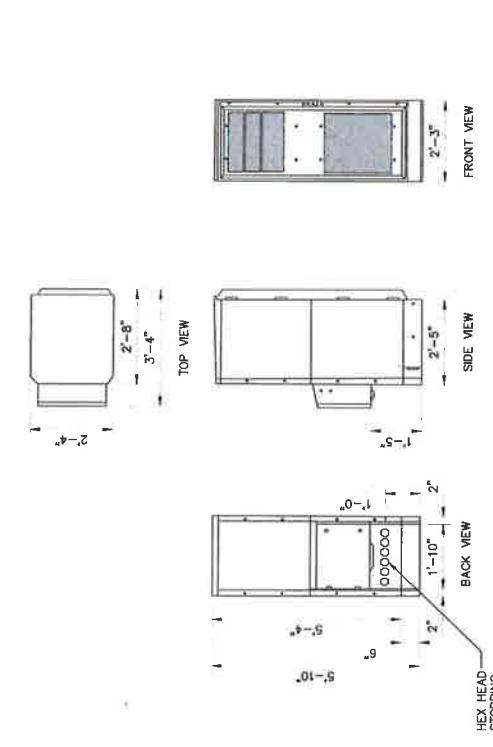

4 **MMBS MECHANICAL SPECIFICATIONS**

SCALE: NTS



1961 NORTHPOINT BLVD., SUITE 130
HUNSON, TN 37343
PH: 423-843-3500 FAX: 423-843-3509

I HEREBY CERTIFY THAT THIS PLAN, SPECIFICATION OR
REPORT WAS PREPARED BY ME OR UNDER MY DIRECT
SUPERVISION AND THAT I AM A DULY LICENSED
ARCHITECT UNDER THE LAWS OF THE STATE OF
MINNESOTA.

JES. SEH
SIGNATURE
PRINT NAME: STEPHEN E. HUNT
DATE: 07/24/13 LICENSE #47398

PROJECT INFORMATION
NETWORK: VISION UNISIUS LAUNCH

ST. PAUL WATER TOWER
MSB3XC472
2100 E. COTTAGE AVE
ST. PAUL, MN 55119
RAMSEY COUNTY
DRAWN BY: SEH CHECKED BY: SEH DATE: 08-19-13

1 **EQUIPMENT DETAILS**
2 **OUTDOOR SPECIFICATIONS**
3 **REVISION**

4 **BBU EQUIPMENT WEIGHT & DIMENSIONS**
5 **BBU MECHANICAL SPECIFICATIONS**

REV: 3

ELECTRICAL NOTES

13. PROVIDE FULL SIZES AND SECTION SOLES WHERE SHOWN OR REQUIRED BY NEC.

ELECTRICAL NOTES (CON'T)


- ALL ELECTRICAL WORK SHALL BE DONE IN ACCORDANCE WITH CURRENT NATIONAL ELECTRICAL CODE AND ALL LOCAL, STATE CODE, LAWS, AND ORDINANCES PROVIDED, ALL COMPONENTS AND WIRING SIZES AS REQUIRED TO MEET NEC STANDARDS.
- CONTRACTOR SHALL COORDINATE WITH LOCAL POWER COMPANY FOR REQUIREMENTS OF POWER SERVICE LINE TO THE METER BASE, WHEN REQUIRED. POWER SERVICE REQUIREMENT IS COMMERCIAL, AC, NOMINAL 120/208 VOLT OR 120/240 VOL, SINGLE PHASE, WITH 200 AMP RATINGS.
- CONTRACTOR SHALL COORDINATE WITH LOCAL POWER COMPANY FOR SERVICE LINE REQUIREMENTS TO TERMINATE THE PPC CABINET.
- CONTRACTOR SHALL FURNISH AND INSTALL ELECTRIC METER, BASE AND 200A DISCONNECT SWITCH, PEERLESS PLATE, DRAINS AND METAL BASE SHOULD BE PROVIDED IN THE EQUIPMENT CABINET, WHERE DESIGNATED BY THE LOCAL POWER COMPANY.
- LOCAL POWER COMPANY SHALL PROVIDE 200 AMP ELECTRIC METER, CONTRACTOR UNDERGROUND POWER AND TELCO SERVICE LINES SHALL BE ROUTED IN A COMMON TRENCH, ALL UNDERGROUND CONDUIT SHALL BE PVC SCHEDULE 40 AND UNLESS OTHERWISE SPECIFIED, ASSOCIATED GROUND SHALL BE GALVANIZED STEEL TUBING 1/2" OR LARGER.
- ALL TELCO CIRCUIT LINES SHALL BE 4" SCH. 40 PVC CONDUIT UNLESS PROVIDED IN THE EQUIPMENT CABINET, WHERE DESIGNATED BY THE LOCAL POWER COMPANY. CONDUIT LENGTHS SHALL NOT EXCEED 100'. CONDUIT LENGTHS SHALL BE ROUTED AND TERMINATED AT THE EQUIPMENT CABINET, IN AN AREA NEAR THE TELCO POLE, IN A FENCED AREA, NEAR UTILITY POLE (IN FENCED AREA) OR END CAP, AND PROVIDE MARKER STAKE PAINTED BRIGHT ORANGE, WITH DESIGNATION FOR TELCO SERVICE.
- CONDUTS INSTALLED AT PCS EQUIPMENT ENDS PRIOR TO THE EQUIPMENT PLATE/FRONT PANEL SHALL BE CUTTED AND CAPPED AT 6" ABOVE GROUND. SERVICE LINES CANT BE INSTALLED INITIALLY, PROVIDE NYLON PULL CORD IN CONDUITS.
- THE SPRINT CABINET, INCLUDING 200 AMP LOAD PANEL AND TELCO PANEL SHALL BE PROVIDED BY OWNER AND INSTALLED BY THE CONTRACTOR. SEE PANEL SPECIFICATIONS ON THIS SHEET FOR GREATER REQUIREMENTS.
- LOCATION OF ELECTRIC METER AND DISCONNECT SWITCH TO BE PROVIDED BY GENERAL CONTRACTOR.
- 100' WIRE TO BE UTILIZED IN ELECTRIC SERVICE RUNS EXCEEDING 100'.
- CONTRACTOR SHALL APPROVE THE DESIGN AND PERIODIC INSPECTION OF CONTRACTORS FUNCTIONS DURING THE PERIOD OF SUBMITTING BIDS. ANY QUESTIONS ARISING DURING THE PERIOD OF SUBMITTING BIDS, CONTRACTORS FUNCTIONS, THE SCOPE OF WORK, OR ANY OTHER ISSUE RELATED TO THIS PROJECT SHALL BE BROUGHT UP DURING THE BID PERIOD WITH THE AWARDED MANAGER FOR CLARIFICATION. NOT AFTER THE CONTRACT HAS BEEN AWARDED.
- LOCATION OF EQUIPMENT, CONDUIT AND DEVICES SHOWN ON THE DRAWINGS ARE ACCORDINGLY, AND SHALL BE COORDINATED WITH FIELD CONDITIONS PRIOR TO ROUGH-IN.
14. THE CONDUIT RUNS SHOWN ON THE DRAWINGS ARE APPROXIMATE, EXACT LOCATION AND ROTATING SHALL BE PER ENTITLED CONDITIONS.





NOTES: GENERAL CONTRACTOR TO CHECK REQUIREMENTS WITH LOCAL POWER COMPANY AND JURISDICTION. ADDITIONAL SUB PANEL FOR THE PPC CABINET, MIGHT BE REQUIRED TO FEED NEW NETWORK VISION EQUIPMENT.

PANEL SCHEDULE

CHT	LOAD DESCRIPTION	AMPS	WIRE	LOAD DESCRIPTION
1	BTS	100	2	OFF ON 2 80 NOT LABELED
2	NOT LABELED	100	2	ON OFF 2 30 NOT LABELED
3	NOT LABELED	10	1	OFF ON 1 20 NOT LABELED
4	FAN	10	1	ON ON 1 20 NOT LABELED

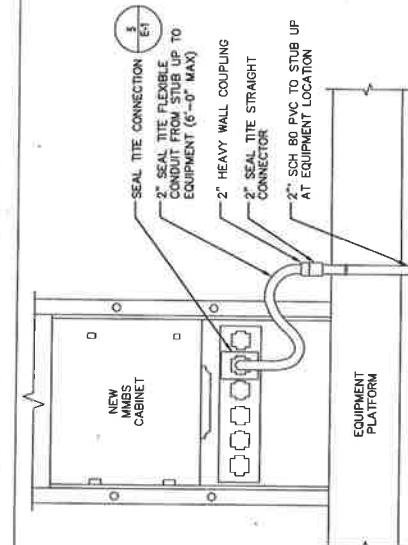

4 TYPICAL EQUIPMENT POWER CONDUIT CONNECTIONS

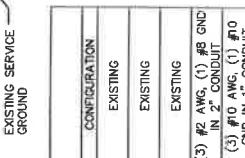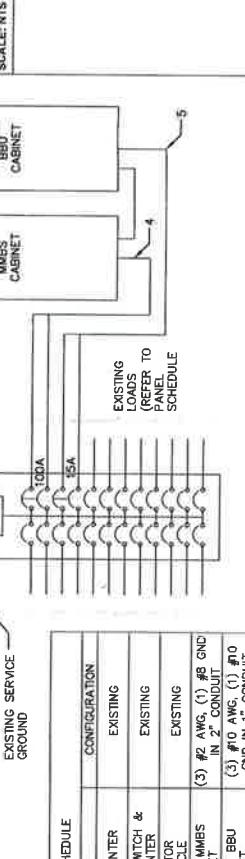

5 SEAL TITE CONDUIT CONNECTION

REV	SHEET NUMBER	ONE-LINE DIAGRAM & POWER PANEL SCHEDULE	TDD	DATE	DRAWN BY	CHEKED BY	ST. PAUL WATER TOWER	PROJECT INFORMATION
REV	DATE 10/24/13	LICENSE #42688	10/24/13	08-19-13	SEH	SEH	1961 NORTHPONT BLVD., SUITE 130 HIXON, TN 37343 PH: 423-843-9500 FAX: 423-843-9509	NET/INDIV. VISION MIGS/LAD/C

E-1

3

2 ELECTRICAL ONE-LINE DIAGRAM



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1961 NORTHPOINT BLVD, SUITE 130
NASHVILLE, TN 37233
PH: 423-843-9500 FAX: 423-843-9509

HEREBY CERTIFY THAT THIS PLAN, SPECIFICATION OR
REPORT WAS PREPARED BY ME OR UNDER MY DIRECT
SUPERVISION AND THAT I AM A DULY LICENSED
ARCHITECT UNDER THE LAWS OF THE STATE OF
MINNESOTA



Jane E. Ulta
SIGNATURE
PRINT NAME: JANE E. ULTA
DATE: 02/24/13 LICENSE #41268

PROJECT INFORMATION
NETWORK VISION MMBS LAUNCH

ST. PAUL WATER TOWER
MS03XC472
2100 E. COTTAGE AVE.
ST. PAUL, MN 55119
RAMSEY COUNTY


DRAWN BY:
TDD
SEH
DATE: 08-19-13
SHEET TITLE: ELECTRICAL DETAILS
SHEET NUMBER: 3
REV: N/A

E-2 3

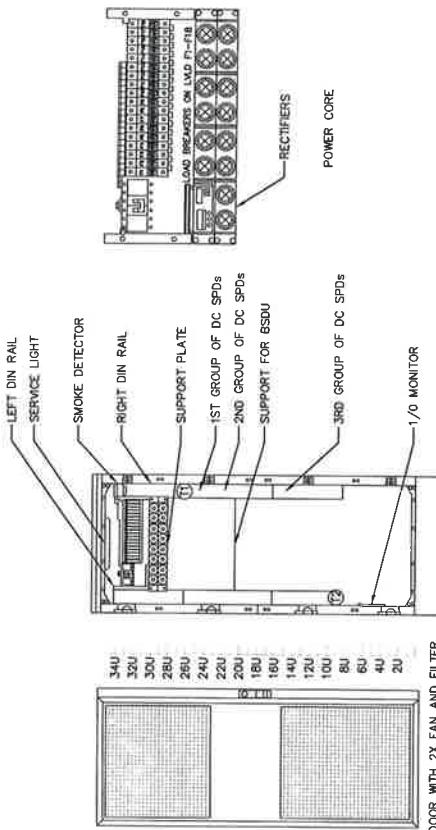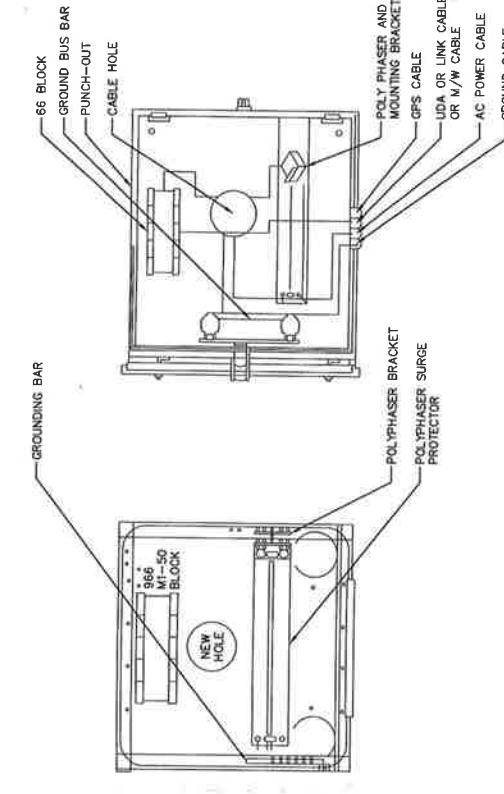

1 MMBS-BBU ELECTRICAL DETAILS
SCALE: NTS

2 MUDROOM ELECTRICAL DETAIL
SCALE: NTS

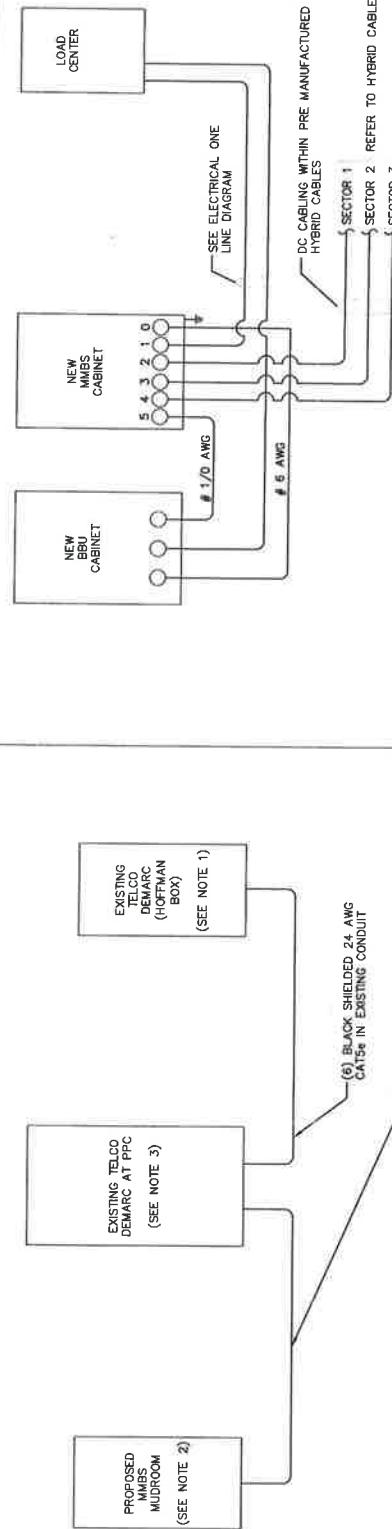

DC POWER ELECTRICAL NOTES.

MINIMUM CABLE LENGTH DISTANCE IS 70MM (2.75 in)
MAXIMUM CABLE LENGTH DISTANCE IS 900mm (35.43 in)
WEATHER PROOFING SHALL INCORPORATE PVC WEATHERPROOF TAPE KIT, COLD SHRINK SHALL NOT
BE USED.
ROUTE DC CONDUCTORS IN CONDUITS TO NEW MMBS CABINET 4BVDC POWER DISTRIBUTION PANEL TO
AND FROM NEW BBU CABINET.
-48 VDC CABLES BETWEEN NEW MMBS CABINET & BBU'S ARE FACTORY ASSEMBLED AND EQUIPPED
WITH ONE PRE-TERMINATED END.
ALL FIELD INSTALLED OC CABLING SHALL BE TYPE RH/RHW AND SHALL BE UL THERMOSET
INSULATED.

NOTES:

1. CONTRACTOR TO INSTALL NEW 66 BLOCK IN EXISTING HOFFMAN BOX AT SITES MAIN TELCO DEMARC.
2. CONTRACTOR SHALL INSTALL RJ-45 BENDS ON ALL (6) RUNS OF CAT5E INTO MMBS-BBU MUDROOM.
3. CONTRACTOR TO INSTALL NEW 66 BLOCK IN EXISTING TELCO BOX NEXT TO EXISTING PPC CABINET.

3 TELCO RISER DETAIL
SCALE: NTS

4 DC POWER DIAGRAM

MMBS PORT LAYOUT	
CONDUIT #	USAGE
0	BATTERY
1	AC/GROUND
2	BBU SECTOR 1
3	BBU SECTOR 2
4	BBU SECTOR 3
5	BATTERY


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GENERAL GROUNDING NOTES:


- ALL DETAILS ARE IN GENERAL TERMS. ACTUAL INSTALLATION AND CONSTRUCTION MAY VARY DUE TO SITE SPECIFIC REQUIREMENTS.
- CRIMPING ALL ANTENNA BASES, FRAMES, CABLE RUNS, AND OTHER METALIC CONDUITS AND CONDUITING SYSTEMS TO SURFACE MOUNTED BUS BARS, FOLLOW ANTENNA AND BRS MANUFACTURER'S PROCEDURES FOR GROUNDS. GROUND COAT SHEDS AT BRS ENDS AND EXIT FROM TOWER OR POLE USING WIRF'S PRACTICES.
- ALL GROUND CONNECTIONS SHALL BE EXOTHERMIC. ALL WIRES SHALL BE COPPER THIN/THIN. ALL GROUND WIRE SHALL BE GREEN INSULATED WIRE ABOVE GROUND.
- CONTRACTOR TO VERIFY AND TEST GROUND TO SOURCE GROUNDING AND OTHER TESTS AS REQUIRED. THIS WILL BE WITNESSED BY SPRINT WIRELESS, LLC. REPRESENTATIVE.
- REFER TO DIVISION 16, GENERAL ELECTRIC, GENERAL ELECTRICAL STANDARDS, PUBLICATION NO. 1990, FOR GROUNDS, GROUNDED CONDUCTORS, GROUNDED PLATES, AND GROUNDED RINGS.
- ELECTRICAL CONTRACTOR TO PROVIDE DETAILED DESIGN OF GROUNDS SYSTEM PER SPRINT STANDARD GROUNDS METHOD, AND RECEIVE APPROVAL OF DESIGN BY AUTHORIZED SPRINT MOBILITY REPRESENTATIVE. PRIOR TO INSTALLATION OF GROUNDS SYSTEM, PHOTO DOCUMENT ALL EXOTHERMIC AND GROUND RING.
- NOTIFY CONSTRUCTION MANAGER IF THERE ARE ANY DIFFICULTIES INSTALLING GROUNDS SYSTEM DUE TO SITE SOIL CONDITIONS.
- FIELD VERIFIED, ANY DEFICIENT ITEMS SHALL BE REPAVED AS REQUIRED TO ACHIEVE ADEQUATE GROUNDS AS REQUIRED BY SPRINT.
- GROUNDING NOTES:
 - EXOTHERMIC WELDS (2), 2 AWG BARE TINNED SOLID COPPER CONDUCTORS TO GROUNDING BAR, ROUTE CONDUCTORS TO BURIED GROUNDING RING AND PROVIDE PARALLEL EXOTHERMIC WELD.
 - EC SHALL USE PERMANENT MARKER TO DRAW THE LINES BETWEEN EACH SECTION AND LABEL EACH SECTION ("P", "A", "N", "T") WITH 1" HIGH LETTERS.
 - ALL HARDWARE 18-8 STAINLESS STEEL INCLUDING LOCK WASHERS, COAT ALL SURFACES WITH AN ANTI-OXIDANT COMPOUND BEFORE MATING. ALL HARDWARE SHALL BE STAINLESS STEEL 3/8 INCH DIAMETER OR LARGER.
 - FOR GROUND BOND TO STEEL ONLY: INSERT A CADMIUM FLAT WASHER BETWEEN LUG AND STEEL, COAT ALL SURFACES WITH AN ANTI-OXIDANT COMPOUND BEFORE MATING.
 - NUT & WASHER SHALL BE PLACED ON THE FRONT SIDE, HEAT-SHRINKING TUBE ISOLATE ALL CONNECTIONS, THE INTENTION IS TO WEATHERPROOF THE COMPRESSSION CONNECTION.
 - NUMBER OF GROUNDING BARS MAY VARY DEPENDING ON THE TYPE OF TOWER, ANTENNA LOCATION, AND CONNECTION ORIENTATION. PROVIDE AS REQUIRED.
 - GROUNDING KIT SHALL BE TYPE AND PART NUMBER AS SUPPLIED OR RECOMMENDED BY CABLE MANUFACTURER.
 - SUPPLIED AND INSTALLED BY CONTRACTOR.
 - WHEN THE SCOPE OF WORK REQUIRES THE ADDITION OF A GROUNDS BAR TO AN EXISTING TOWER, THE SUBCONTRACTOR SHALL OBTAIN APPROVAL FROM THE TOWER OWNER PRIOR TO MOUNTING THE GROUNDS BAR TO THE TOWER.
 - EXTEND TWO (2) 2 AWG TINNED CU CONDUCTOR FROM BURIED GROUNDING RING AND CONNECT TO THE PROPOSED TOWER. (APPLICABLE TO NEW TOWERS ONLY.)
 - NUMBER OF GROUNDS BARS MAY VARY DEPENDING ON THE TYPE OF TOWER, ANTENNA LOCATION, AND CONNECTION ORIENTATION. THE SUBCONTRACTOR SHALL BE RESPONSIBLE FOR INSTALLING ADDITIONAL GROUNDS BARS AS REQUIRED, PROVIDING 50% SPARE CONNECTION POINTS.
 - EXPOSED GROUND WIRES TO BE NON METALLIC LIQUID TIGHT.



1 EQUIPMENT GROUND & ROUTING PLAN (EXISTING)

11x17 SCALE: 1'=6"

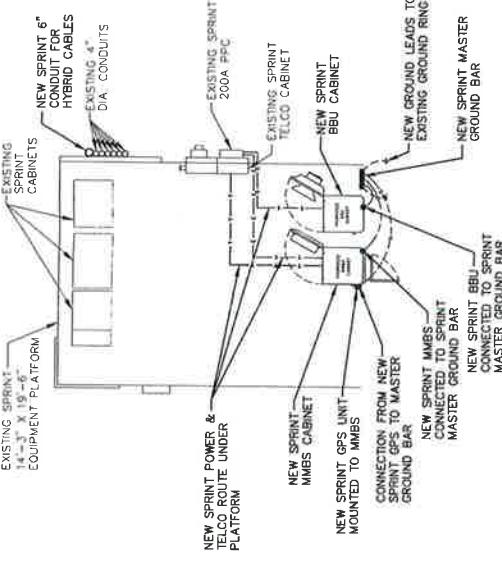
24x36 SCALE: 1'=4"

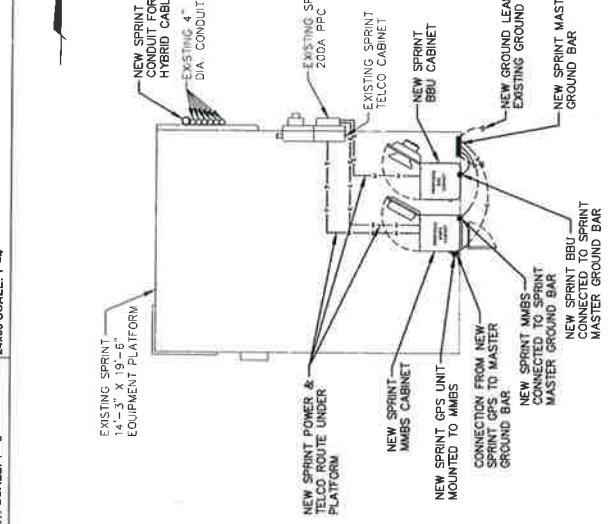

3 EQUIPMENT GROUND & ROUTING PLAN (FINAL)

11x17 SCALE: 1'=6"


24x36 SCALE: 1'=4"

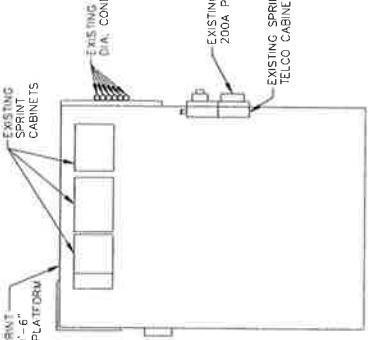

2 EQUIPMENT GROUND & ROUTING PLAN (INTERIM) IF REQUIRED

11x17 SCALE: 1'=8"

24x36 SCALE: 1'=4"

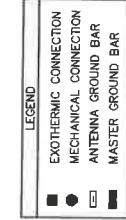

NOTE:
1. CONTRACTOR TO REPLACE ALL MISSING GROUND BARS AND GROUNDING CONNECTIONS AS REQUIRED

ST. PAUL WATER TOWER
PROJECT NUMBER: 7413 LICENSE #2488

MS03XC472

2100 E. COTTAGE AVE.
ST. PAUL, MN 55119
RAMSEY COUNTY

OWNER: TDD
ARCHITECT: SEH
DATE: 08-19-13
SHEET TITLE: GROUNDING &
ROUTE PLANS
SHEET NUMBER: REV. 1

ST. PAUL WATER TOWER

PROJECT NUMBER: 7413 LICENSE #2488

MS03XC472

2100 E. COTTAGE AVE.
ST. PAUL, MN 55119
RAMSEY COUNTY

OWNER: TDD
ARCHITECT: SEH
DATE: 08-19-13
SHEET TITLE: GROUNDING &
ROUTE PLANS
SHEET NUMBER: REV. 1

E-3


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4 GROUNDING NOTES

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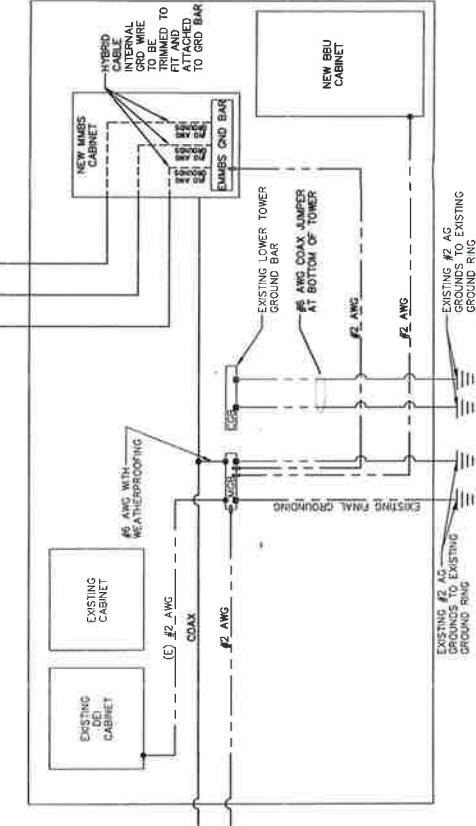
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1961 NORTHPOINT BLVD., SUITE 130
HIXON, TN 37343
PH: 423-843-9500 FAX: 423-843-9509

GROUNDING NOTES

- ALL GROUNDING CONNECTIONS SHALL BE MADE BY EXOTHERMIC WELDS. EXOTHERMIC WELDS SHALL INCLUDE ALL CABLE TO CABLE, SPLICES, ETC. ALL CABLE TO GROUND, GROUND RODS, SPLICES AND LIGHTING PROTECTIONS MATERIALS AS INDICATED. GROUND FOUNDATION ONLY AS INDICATED BY PH. ALL MATERIALS USED (NAILS, WELDING, METAL, TOOLS, ETC.) SHALL BE EXOTHERM WELDED. PER MANUFACTURERS RECOMMENDATIONS AND PROCEDURES. GROUND CONDUCTOR SHALL HAVE A MINIMUM 24" BENDING RADIUS.
- ALL EXOTHERMIC WELD CONNECTIONS ON GALVANIZED SURFACES SHALL BE CLEANED THOROUGHLY AND COLORED TO MATCH SURFACE WITH (2) TWO COATS OF GALVATE (WHITE) PAINT, OR SILVERBRITE (ALUMINUM).
- ALL ELECTRICAL & MECHANICAL GROUND CONNECTIONS SHALL HAVE ANTI-OXIDANT COMPOUND APPLIED TO CONNECTION.
- GROUND TESTS SHALL BE PERFORMED AS REQUIRED BY SPRINT STANDARD PROCEDURES. GROUND GRID RESISTANCE SHALL NOT EXCEED 5 OHMS.
- CONTRACTOR SHALL SUBMIT THE GROUND RESISTANCE TEST REPORT AS FOLLOW:
 - ONE (1) COPY TO OWNER REPRESENTATIVE
 - ONE (1) COPY TO ENGINEER
 - ONE (1) COPY TO KEEP INSIDE EQUIPMENT INCLOSURE
- ALL RADIO EQUIPMENT AND UTILITY CABINETS GROUNDS LEADS TO BE #2 AWG STRANDED GREEN WIGLETT FROM BUSS TERMINAL.
- FOR ADDITIONAL GROUNDING NOTES SHEET E&I.
- ALL ANTENNA MOUNT GROUNDS SHALL BE #2 AWG STRANDED GREEN JACKLED CABLE GROUNDS SHALL BE BLACK FROM MFR.
- ALL GROUND WIRES FROM GROUND BARS TO GROUND SHALL BE #2 AWG SOLID BARE AS REQUIRED.
- ALL ABOVE GROUND WIRES SHALL BE GREEN JACKLED. ALL GROUND WIRES PENETRATING INTO GROUND AND BELOW SHALL BE SOLID BARE.

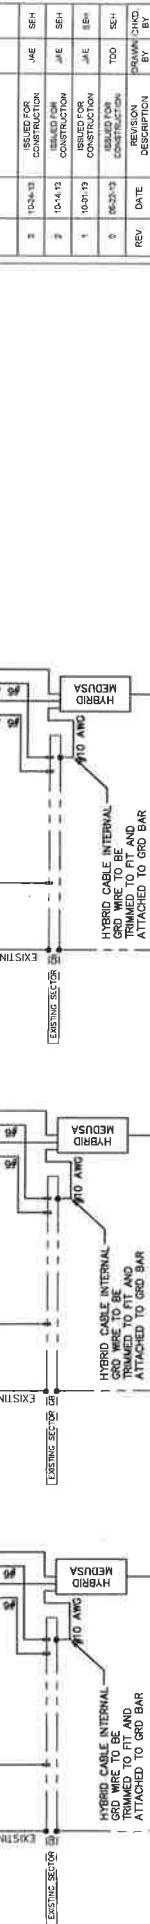

SHEET NUMBER:

REV:

REV:	3
TDD	08-19-13
DRILLER	SEH
PRINT NAME:	STÉPHANE HUOT
DATE:	07-24-13
PROJECT INFORMATION	NETWORK UBIQUITI MBB LANSCH



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Antennas • Systems • Solutions

WINN

<p>NOTES:</p> <ol style="list-style-type: none"> DO NOT INSTALL CABLE GROUND KIT AT A BEND AND ALWAYS DIRECT GROUND WIRE DOWN TO ANTENNA GROUND BAR. WEATHER PROOFING SHALL BE ANDREWS, TYPE & PART NUMBER AS SUPPLIED OR RECOMMENDED BY CABLE MANUFACTURER. <p>RRU TO ANTENNAS</p> <p>TOTAL OF 6 LINES PER SECTOR IF THE SITE HAS BOTH BDU AND RRU</p> <p>WEATHERPROOFING KIT (TPR)</p> <p>STANDARD GROUND KIT (TPR) (SEE REF 7A & 5)</p> <p>ANTENNA CABLE TO SHELTER (TPR)</p> <p>ANTENNA GROUND KIT (KEY MOUNT GROUND HARNESS KIT) MOUNT ON TOWER OR WALKDOWN LADDER.</p> <p>CONNECTOR WEATHERPROOFING KIT (TPR) SEE NOTE 2</p> <p>ANTENNA CABLE</p> <p>1. DO NOT INSTALL CABLE GROUND KIT AT A BEND AND ALWAYS DIRECT GROUND WIRE DOWN TO GROUND BAR.</p> <p>2. GROUNDING KIT SHALL BE ANDREW SURGEGROUND TYPE KIT WITH TWO-HOLE LUG.</p> <p>3. WEATHER PROOFING SHALL INCORPORATE PDC WEATHERPROOF TAPE KIT, COLD SHARK SHALL NOT BE USED.</p>		<p>12'- TO 24'- 2 1/2" MAX WEATHERPROOFING KIT (SEE NOTE 3) CABLE GROUND KIT #1 AWG STRANDED COPPER GROUND WIRE (GROUNDED TO GROUND BAR) (SEE NOTE 1 & 2)</p> <p>NOTES: 1. DO NOT INSTALL CABLE GROUND KIT AT A BEND AND ALWAYS DIRECT GROUND WIRE DOWN TO GROUND BAR. 2. GROUNDING KIT SHALL BE ANDREW SURGEGROUND TYPE KIT WITH TWO-HOLE LUG. 3. WEATHER PROOFING SHALL INCORPORATE PDC WEATHERPROOF TAPE KIT, COLD SHARK SHALL NOT BE USED.</p>	
<p>1 TYP COAX GROUNDING</p> <p>SCALE: NTS</p>		<p>2 CABLE GROUNDING</p> <p>SCALE: NTS</p> <p>NOTES: 1. DO NOT INSTALL CABLE GROUND KIT AT A BEND AND ALWAYS DIRECT GROUND WIRE DOWN TO GROUND BAR. 2. GROUNDING KIT SHALL BE ANDREW SURGEGROUND TYPE KIT WITH TWO-HOLE LUG.</p>	
<p>3 TWO HOLE LUG</p> <p>SCALE: NTS</p>		<p>4 CABINET GROUNDING SCHEMATIC</p> <p>SCALE: NTS</p> <p>NOTES: PROVIDE NO-COK GREASE AT CONTACT SURFACE BETWEEN LUG AND GROUND BAR *CONTRACTOR WILL VERIFY BLUS BAR GROUNDING TO THE TOWER OR RING</p>	
<p>5 TYPICAL EXOTHERMIC WELD CONNECTIONS</p> <p>SCALE: NTS</p>		<p>6 SECTOR GROUND BAR CONNECTIONS</p> <p>SCALE: NTS</p> <p>NOTES: PROVIDE NO-COK GREASE AT CONTACT SURFACE BETWEEN LUG AND GROUND BAR</p>	
<p><i>[Handwritten signatures]</i></p> <p>PART NAME: STEPHEN EHRNSTEIN DATE <u>12-4-13</u> LICENSE #4769</p> <p>PROJECT INFORMATION NETWORX VISION KIRKES (LAUNCH) DRAWN BY: TDD SHEET TITLE: GROUNDS DETAILS REV: SEH</p> <p>2100 E. COTTAGE AVE. ST. PAUL, MN 55119 RAMSEY COUNTY</p> <p>MS03XC472</p> <p>ST. PAUL WATER TOWER</p> <p>GROUNDS AT BOTTOM OF TOWER OR MONPOLE EXOTHERMIC CONNECTION</p> <p>* GROUND BARS AT BOTTOM OF TOWER OR MONPOLE EXOTHERMIC CONNECTION</p> <p>EXOTHERMIC WELD WITH #2 AWG SOLID TINNED GROUNDBAR LEADS TO EACH SECTOR GROUND BAR COAX CABLE LEADS</p> <p>GROUNDBAR ON WALL FLOOR OR ANTEANA TOWER</p> <p>GROUND LEADS TO EACH SECTOR GROUND BAR COAX CABLE LEADS</p> <p>EXOTHERMIC WELD WITH #2 AWG SOLID TINNED GROUNDBAR LEADS TO EACH SECTOR GROUND BAR COAX CABLE LEADS</p> <p>GROUNDBAR ON WALL FLOOR OR ANTEANA TOWER</p>			

GR-2 3

SCALE: NTS

EXHIBIT "D"

SPRINT SPECTRUM L.P.
MS03XC472
2095 Clear Ave E, Saint Paul, MN

Antenna Facilities and Frequencies

1. Shelter and Shelter Components

Sprint has 1 equipment platform 19'6" x 14'3" and lease space of approximately 750 square feet.

Power plant (DC current): Rectifiers installed inside MMBS BBV Cabinet

Battery supply back up: Installed inside MMBS BBV Cabinet

T-1 switch equipment: In existing utility h-frame

Commercial switch gear equipment: In existing utility h-frame

Radio transmitters: Installed inside MMBU Cabinet and behind the antennas in the form of RRU's.

Air conditioner: N/A

2. Generators: N/A

3. Antennas

Quantity: (3) Total; (1) per Sector

Type: Manufacturer: (3) Powerwave

Azimuths: 0; 120; 240

Model: (3) P90-15-XLPP-RR

Dimensions: (3) 72" x 12" x 7.3"

Weight: 64 lbs ea.

Type: Panel

Centerline of the antenna: 74' AGL

4. Coax Cable

Number of lines: N/A

Type:

Size:

5. Tower Mounted Amplifiers (TMAs) N/A

Quantity:

Manufacturer:

Model:

Dimensions:

Weight:

Mounting:

6. Diplexers N/A

Quantity:

Manufacturer:

Model:

Dimensions:

Weight:

7. Remote Radio Heads (RRHs)

Quantity: (6) Total; (2) per Sector

Manufacturer: Samsung

Model: (3) RRH-P4, (3) RRH-C2A

Dimensions: (3) 19.3''x15.7''x6.7'', (3) 13.8''x23.8''x9''

Weight: (3) 52lbs, (3) 60lbs

Mounting: Pipe

Hybrid Jumper: (3) 1/2" 6'

8. Distribution Box (COVP) N/A

Quantity:

Manufacturer:

Model:

Dimensions:

Weight:

9. Sector Box N/A

Quantity:

Manufacturer:

Model:

Dimensions:

Weight:

10. Hybrid Cable

Type: Samsung HFC

Number of Lines: (3) Total

Junction Cylinders: (3) Power & (3) Fiber

11. Frequencies

Svc	Technology	EIRP (WATTS)	Frequencies				
			Std Frequency	Transmit		Receive	
				Start	Stop	Start	Stop
1	1900 CDMA/EVDO	748.17		1930.625	1939.375	1850.625	1859.375
2	1900 LTE FDD	794.32		1990.625	1994.375	1910.625	1914.375
3	800 CDMA	433.51		862.275	863.525	817.275	818.275
4	800 LTE FDD	461.32		863.8	868.8	818.8	823.8

EXHIBIT "E"
SECURITY PLAN

Remote Facilities Access
Saint Paul Regional Water Services (SPRWS)
Standard Operating Procedure (SOP)
Effective Date: November 15, 2010

INTENT:

SPRWS is dedicated to providing its employees with the safest work environment possible and to taking every reasonable precaution to ensure the safety of potable water delivered to our communities. This SOP provides conditions for persons with need to access SPRWS facilities outside the McCarrons Center facilities (Remote Facilities). It establishes procedures for access and responsibilities for both those wishing to enter remote facilities and those allowing such access.

SECURITY OF FACILITIES:

Persons with routine access to remote facilities include SPRWS staff, agents of entities leasing space, agents of various cities, and various law enforcement personnel. Other entities also have occasional access needs under the supervision of SPRWS staff. With so many persons having legitimate access needs, it is imperative that specific procedures be established to ensure that the highest level of security possible. As a result, the following procedures are established:

1.0 SITE ACCESS REQUIREMENTS

- 1.01 Request to access site required prior to entry. Important: note that the police will be called to the site if a call is not made to SPRWS prior to entry.

Note: all requests for entry to remote sites must be made through the Engine Room! Any other employee asked to allow entry to a remote site must inform the requester to call the Engine Room so that they can be cleared for entry.

- a) Routine and regularly scheduled

Whenever possible, authorized agencies that require repeated, routine access should schedule such access during normal business hours at least one day in advance by calling SPRWS Engine Room at 651-266-1660. The Engine Room Pumping Engineer will record the name of the agent and arrange for crew to meet agent on site and allow for access after checking for proper ID. Pumping Engineer will verify that agents requesting access are those that arranged for the access previously, and pass the authorized agents names to the field crew for verification in the field. If access is allowed, field crew will notify Engine Room that an entry to a site will occur.

- b) Emergencies

1. Contact Engine Room 651-266-1660.

2. Engine Room Pumping Engineer (PE II) will check against a list of authorized companies for each site to ensure that a particular company has reason to be on site.
3. If company is authorized, PE II will make arrangements with the Distribution after-hours Turn-On truck to allow for access at the site.
4. Distribution personnel will be responsible to verify the identity of the agent(s) and to monitor agent(s') activity at the site.
5. Under certain conditions, Distribution personnel may not be available, in which case PE IIs will use their best judgment to determine if there is another way to grant access to the agent, or to deny or delay access.

1.02 While at site:

- a) Authorized agents are required to perform their necessary work on the site in a manner that does not compromise site security. This includes, but is not limited to, securing all doors and gates before leaving the site.
- b) SPRWS employees will determine whether or not they will need to monitor the activity at the site. If SPRWS employee believes that the agent is not there for a legitimate business reason, the employee should get to a safe area and call 911 to have police confront the agent and remove them if necessary. In this event, SPRWS employee should also call the Engine Room to inform them of the proceedings.

1.03 Leaving site:

- a) Authorized agents must notify Engine Room 651-266-1660 when leaving the site.

2.0 IDENTIFICATION PROCEDURES

2.01 All SPRWS staff and personnel are issued a SPRWS photo identification card (ID card) at the McCarrons facility. This ID is to be displayed above the waist. Anyone purporting to be a SPRWS employee should be asked to display this ID card if it is not visible.

Contractors or agents seeking entrance to a remote facility are required to show a valid driver's license. SPRWS employee allowing them access will forward the name and phone number of the entrant to the Engine Room to confirm that access should be granted.

3.0 FACILITY LOCKS

3.01 All Remote Facilities will be secured with high-security locks utilizing high-security keys.

- a) Locks will be furnished and installed by SPRWS.
- b) No other locks are permitted, and all such other locks will be removed and disposed of.
- c) SPRWS may make some exceptions in cases where, for the convenience of SPRWS staff, contractor locks will be allowed to be “daisy-chained” onto a SPRWS facility. These exceptions will be on a case by case basis, and the decision to allow this will be made by SPRWS security officer.
- d) For sites that are undergoing construction, SPRWS will install construction locks and give contractors construction keys.

3.02 Issuance of Keys

- a) SPRWS staff that require access, as determined by the appropriate SPRWS division manager, will be issued keys. Such keys will be reduced to the lowest possible number.
 - 1. SPRWS staff are responsible for the safe keeping of keys issued to them.
 - 2. Repeated lost keys will be considered negligence and may result in corrective action and/or discipline by SPRWS management.
- b) Key audits will be conducted at least once each calendar year.
 - 1. Each SPRWS staff member, and each Authorized Agent, to whom SPRWS keys were issued will be required to sign a key Audit Statement acknowledging their continued possession of the key.
 - 2. Both Public and Private Agencies are responsible for the return of all keys and/or contractor keys issued to their agents who leave their employ or are no longer required by the Authorized Agency to access SPRWS facilities. Lost keys must be reported immediately to SPRWS by contacting the Engine Room at 651-266-1660.
 - 3. Repeated losses may result in deposit requirements, as may be determined necessary by SPRWS staff.

4.0 SPRWS CONTACTS

Normal and emergency access after normal business hours:
PE II 651-266-1660.

CONTRACTOR PROCEDURES FOR ENTERING SPRWS WATER TOWER FACILITIES

Routine Accesses:

- 1) Notify SPRWS Pumping Engineer at 651-266-1660 of desired access at least 24 hours prior to accessing site. Pumping Engineer will verify that company has agreement to be on site, and if so will arrange for crew to meet contractor at designated time and place. Contractor must provide names of all employees that will access the site.
- 2) At time of arranged access, provide IDs (in the form of valid driver's licenses) for SPRWS field crew. If IDs match the names given to the Pumping Engineer, crew will provide access. If not, no access will be provided.
- 3) SPRWS field crew may accompany contractor while they are on site. If the crew does not accompany contractor, contractor must call the Pumping Engineer when they leave the site.

Emergency Accesses:

- 1) Notify SPRWS Engine Room at 651-266-1660 of need to access site.
- 2) Engine Room Pumping Engineer will verify that contractor has an agreement to be on a particular site.
- 3) If contractor has agreement to be on site, and a reasonable explanation of the emergency is given, Pumping Engineer will arrange for a crew to meet contractor at the site.
- 4) Contractor will need to produce IDs and work orders.
- 5) If OK, crew will allow for access.
- 6) Repeated emergencies will be cause for SPRWS to bill the contractor or deny access.
- 7) Contractor will call Engine Room when leaving site.

- End -

Exhibit "F"
Memorandum of Lease Recording

DRAFTED BY
AND RETURN TO:

(space above this line for Recorder's use only)

MEMORANDUM OF LEASE

THIS MEMORANDUM OF LEASE is entered into as of this _____ day of _____, 2017, by and between **BOARD OF WATER COMMISSIONERS OF THE CITY OF SAINT PAUL**, a municipal corporation under the laws of the State of Minnesota ("Lessor"), and **SPRINT SPECTRUM L.P.**, a limited partnership organized and existing under the laws of Delaware, ("Lessee").

1. LEASE OF PREMISES. For the purpose of installing, operating, and maintaining a communication facility and other improvements, Lessor hereby leases to Lessee, and Lessee hereby leases from Lessor, certain premises located at 2095 Clear Ave E, City of Saint Paul, County of Ramsey, State of Minnesota, and more particularly described in Section 4 of this Memorandum, and on the terms and conditions more particularly set forth in, that certain Site Lease Agreement dated April 01, 2017 (the "Lease") by and between Lessor and Lessee, which terms and conditions are hereby incorporated by reference.
2. The initial term of the Lease shall commence on April 01, 2017, and terminate on March 31, 2022. Lessee shall have the right to extend the Lease for three (3) additional five (5) year terms.
3. The Lease provides in part the grant of a non-exclusive easement for unrestricted rights of access and to electric and telephone facilities.

4. The subject property affected by the filing and recording of this Memorandum of Lease is described below:

That part of the Southeast Quarter (SE $\frac{1}{4}$), Section twenty-three (23), Township twenty-nine (29), Range twenty-two (22), commencing at a point 678.71 feet East of the Northwest corner of Lot 12, Katherine's Addition, according to the recorded plats thereof on file and of record in the Office of the Registrar of Titles, in and for Ramsey County, Minnesota; thence South 268.97 feet to a point 711.69 feet Easterly from the West line of the Northwest Quarter (NW $\frac{1}{4}$) of the Southeast Quarter (SE $\frac{1}{4}$) of Section twenty-three (23), Township twenty-nine (29), Range twenty-two (22) Ramsey County, Minnesota; thence Easterly 162 feet; thence Northerly to the South line of Cottage Avenue. All in Ramsey County, Minnesota

(Signature and Acknowledgement Pages Follow)

Lessor:

Approved:

By _____

Stephen P. Schneider, General Manager
Saint Paul Regional Water Services

Approved as to form:

By _____

Assistant City Attorney

**BOARD OF WATER COMMISSIONERS
OF THE CITY OF SAINT PAUL**
EIN 41-6005521

By _____

Matt Anfang, President

By _____

Mollie Gagnelius, Secretary

Date _____

CITY OF SAINT PAUL

By _____

Kristin Beckmann, Deputy Mayor

By _____

Shari Moore, City Clerk

By _____

Todd Hurley, Director
Office of Financial Services

Date _____

For Lessee:

SPRINT SPECTRUM L.P.

By: _____

Print name: _____

Title: _____

Date: _____

EXHIBIT "F"

ACKNOWLEDGEMENTS

BOARD OF WATER COMMISSIONERS OF THE CITY OF SAINT PAUL

STATE OF MINNESOTA)
) ss.
COUNTY OF RAMSEY)

The foregoing instrument was acknowledged before me this _____ day of _____, 2017,
by Matt Anfang, President of the Board of Water Commissioners of the City of Saint Paul, a Minnesota
municipal corporation, on behalf of said corporation.

Witness my hand and official seal.

Notary Public

STATE OF MINNESOTA)
) ss.
COUNTY OF RAMSEY)

The foregoing instrument was acknowledged before me this _____ day of _____, 2017,
by Mollie Gagnelius, Secretary of the Board of Water Commissioners of the City of Saint Paul, a
Minnesota municipal corporation, on behalf of said corporation.

Witness my hand and official seal.

Notary Public

CITY OF SAINT PAUL

STATE OF MINNESOTA)
) ss.
COUNTY OF RAMSEY)

The foregoing instrument was acknowledged before me this _____ day of _____, 2017,
by Kristin Beckmann, Deputy Mayor of the City of Saint Paul, a Minnesota municipal corporation, on
behalf of said corporation.

Witness my hand and official seal.

Notary Public

STATE OF MINNESOTA)
) ss.
COUNTY OF RAMSEY)

The foregoing instrument was acknowledged before me this _____ day of _____, 2017,
by Shari Moore, City Clerk of the City of Saint Paul, a Minnesota municipal corporation, on behalf of
said corporation.

Witness my hand and official seal.

Notary Public

STATE OF MINNESOTA)
) ss.
COUNTY OF RAMSEY)

The foregoing instrument was acknowledged before me this _____ day of _____, 2017,
by Todd Hurley, Finance Director of the City of Saint Paul, a Minnesota municipal corporation, on behalf
of said corporation.

Witness my hand and official seal.

Notary Public

LESSEE

STATE OF _____)
) ss.

COUNTY OF _____)

The foregoing instrument was acknowledged before me this ____ day of _____, 2017,
by Dan Davis, Area Site Development Manager, Sprint Spectrum Realty Company, LLC organized and
existing under the laws of Delaware, on behalf of said corporation.

Witness my hand and official seal.

Notary Public