

Project


**981 University Ave.
Parklet & Parking Improvements**
981 University Avenue W.
St. Paul, MN 55104

Owner


Johnny Baby's
981 University Avenue W.
St. Paul, MN 55104
contact: Jonathan Price
651.983.1151

Development Assistance

Neighborhood Development Center
663 University Avenue W.
St. Paul, MN 55104
contact: Sarah Emmel
651.291.2480

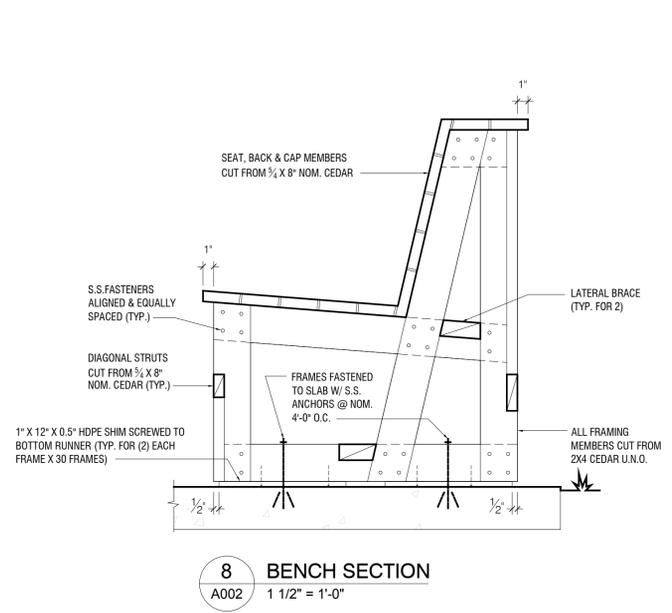


8 BENCH SECTION
A002 1 1/2" = 1'-0"

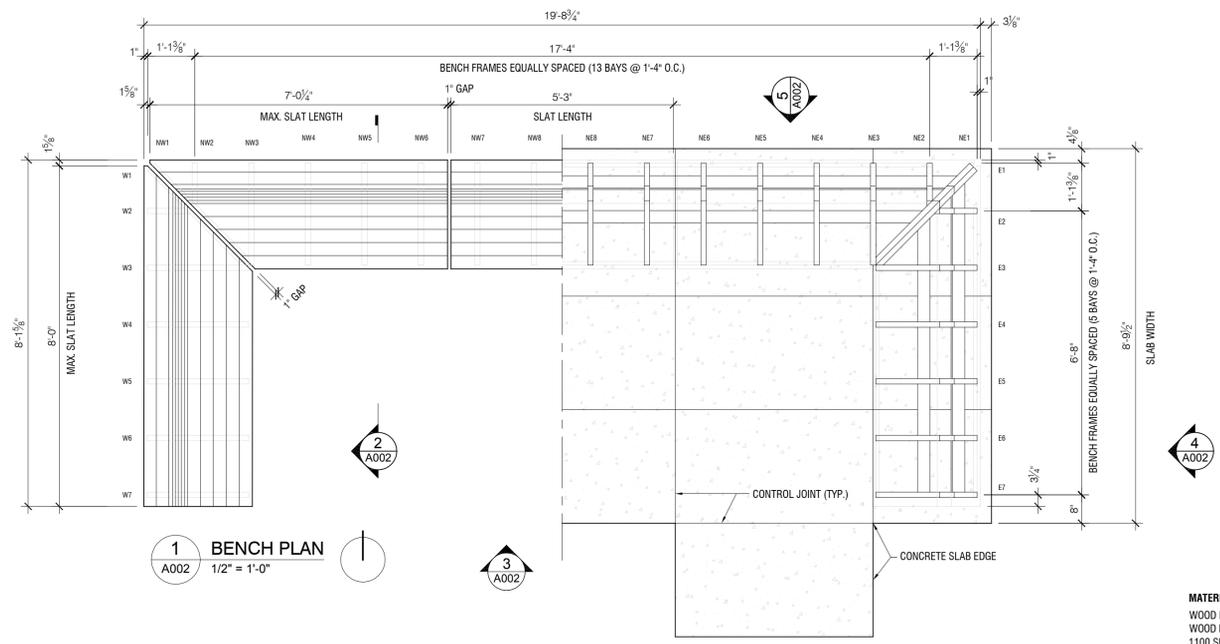


1 BENCH PLAN
A002 1/2" = 1'-0"


MATERIAL NOTES
WOOD PRODUCTS: WESTERN RED CEDAR.
WOOD FINISH: ONE (1) COAT CABOT SEMI-SOLID ACRYLIC SIDING WOOD STAIN, 1100 SERIES, COLOR TO BE SELECTED.
FASTENERS: STAINLESS STEEL FASTENERS TO BE APPROVED BY ARCHITECT.
SHIM STOCK: HIGH-DENSITY POLYETHYLENE (HDPE), COLOR BLACK.

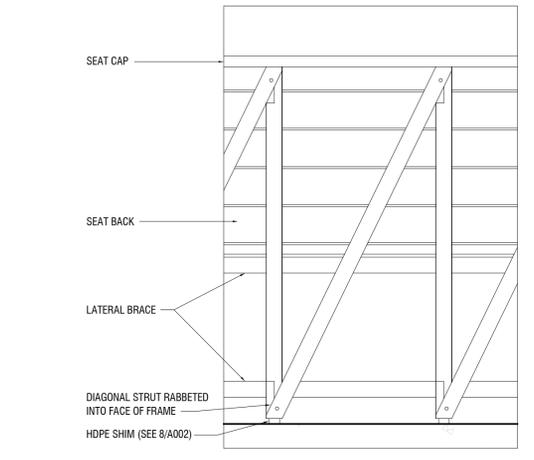


9 ELEVATION DETAIL
A002 1 1/2" = 1'-0"

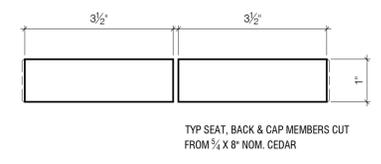


10 SEAT MILLING DIAGRAM
A002 6" = 1'-0"

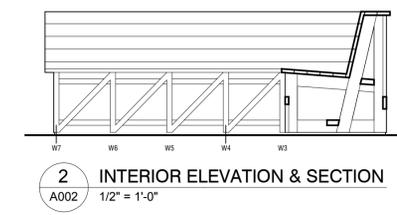

2 INTERIOR ELEVATION & SECTION
A002 1/2" = 1'-0"

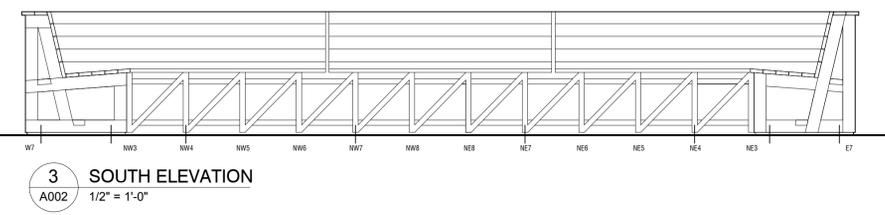


3 SOUTH ELEVATION
A002 1/2" = 1'-0"

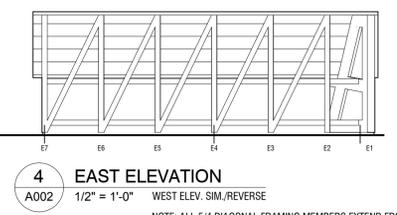


4 EAST ELEVATION
A002 1/2" = 1'-0" WEST ELEV. SIM. REVERSE


NOTE: ALL 5/4 DIAGONAL FRAMING MEMBERS EXTEND FROM LOWER LEFT TO UPPER RIGHT ON ALL 6 SIDES OF BENCH

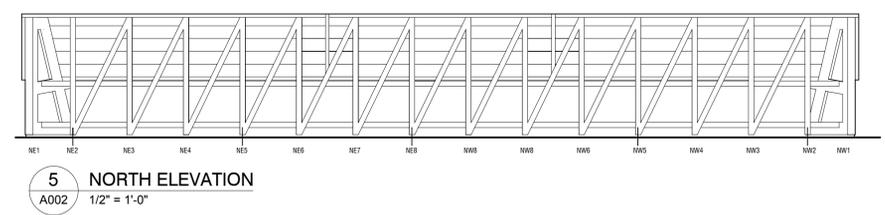

5 NORTH ELEVATION
A002 1/2" = 1'-0"

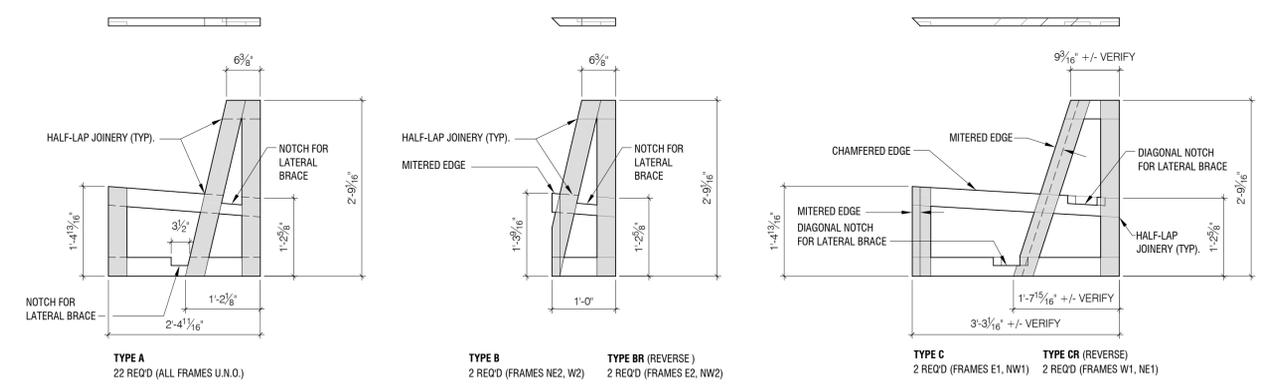

6 FRAME DIAGRAMS
A002 3/4" = 1'-0"

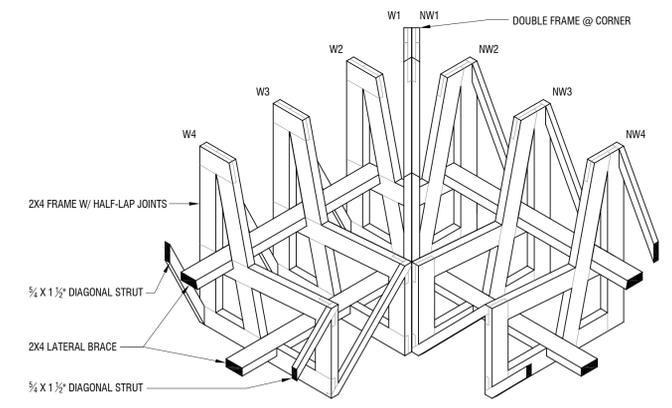

7 FRAMING ISOMETRIC
A002 3/4" = 1'-0"

NORTHWEST CORNER SHOWN
NORTHEAST CORNER SIMILAR

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Certification
I hereby certify that this plan, specification or report was prepared by me or under my direct supervision and that I am a duly registered architect or engineer under the laws of the State of Minnesota.

Paul Gates
Signature

Registration Number 40330 Date 08.22.16

Date of Issue
August 22, 2016


Issued For
Site Plan Review & Permit

Revisions
No. Date Issue

Project Number
1412

Sheet Name
Bench Drawings

Sheet Number

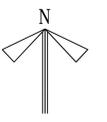


NORTH

Revision 2
09/08/16

L001




PUBLIC ALLEY

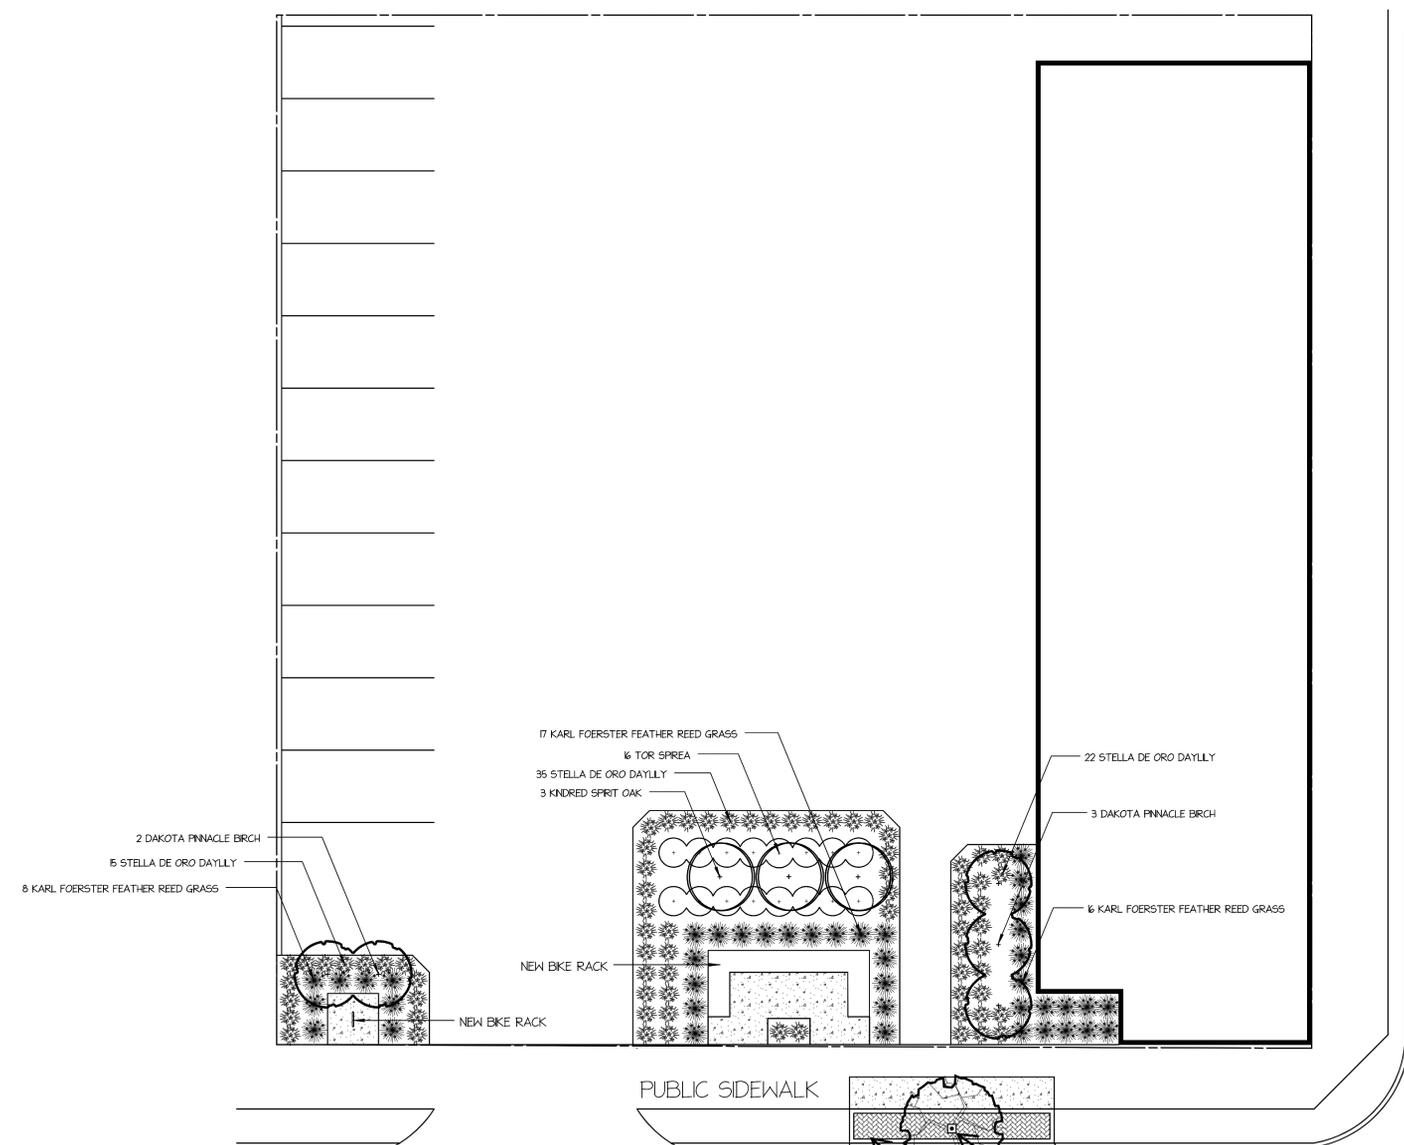

PUBLIC SIDEWALK

UNIVERSITY AVE W



SIENNA GLEN MAPLE IN EXISTING TYPE 1 TREE TRENCH & STRUCTURAL SOILS LOCATED BENEATH EXISTING CURB CUT. CONFIRM LOCATION OF TREE TRENCH FOLLOWING REMOVAL OF EXISTING CURB CUT.
PERMEABLE CONCRETE PAVERS INSTALLED PER DETAIL. MATCH EXISTING PAVERS.

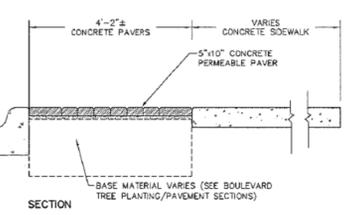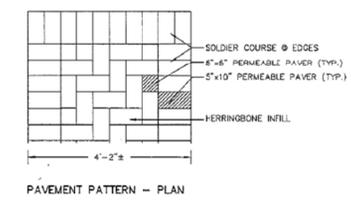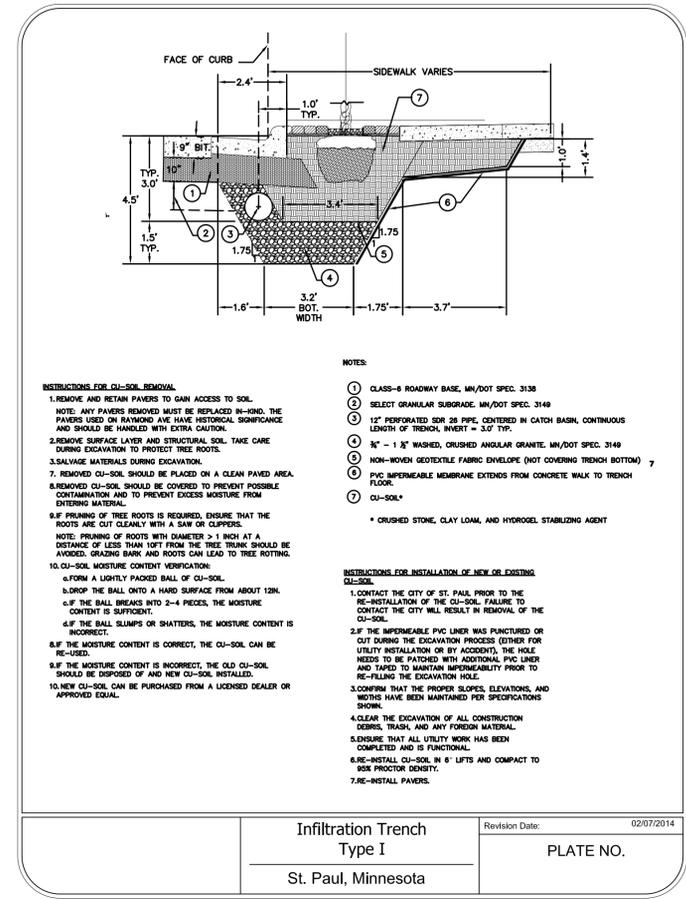

CONC. PERMEABLE PAVEMENT EDGE BAND PATTERN

TREE PLANTING NOTES:

- EXPOSE ROOT FLARE & SET AT GRADE
- FOR B+B TREES PLANTED IN RIGHT OF WAY, REMOVE BURLAP & ROPES FROM TOP 1/3 OF ROOT BALL, CUT WIRE BASKET DOWN TO SECOND HORIZONTAL WIRE FROM THE BOTTOM, AND DISPOSE OFFSITE.

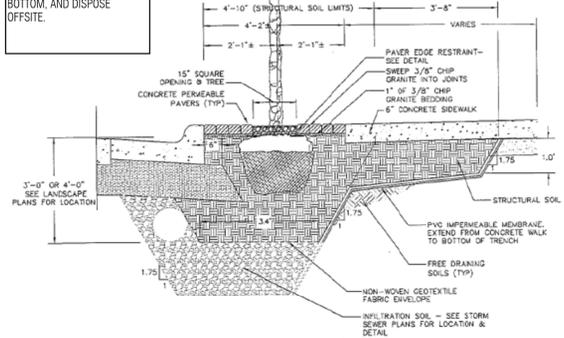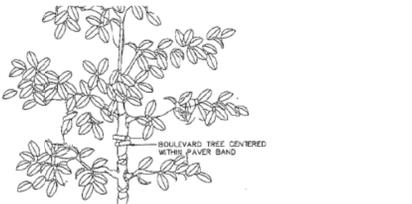

BOULEVARD TREE PLANTING W/ PERMEABLE PAVERS - SECTION

Qty	Botanical Name	Common Name
Trees		
5	Betula platyphylla 'Dakota Pinnacle'	DAKOTA PINNACLE BIRCH
3	Quercus robur x bicolor 'Nadler'	KINDRED SPIRIT OAK
Shrubs		
16	Spiraea betulifolia 'Tor'	TOR SPIREA
Ornamental Grasses		
41	Calamagrostis x acutiflora 'Karl Foerster'	KARL FOERSTER FEATHER REED GRASS
Perennials and Annuals		
72	Hemerocallis 'Stella de Oro'	STELLA DE ORO DAYLILY

Trees
1 Acer x freemanii 'Siena' SIENNA GLEN MAPLE

Questions about tree planting in the boulevard tree trench can be directed to Zach Jorgensen at 651.632.2437

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